



GENERAL NOTES

THIS DRAWING IS TO BE READ IN CONJUNCTION WITH ALL RELEVANT ARCHITECT'S AND ENGINEER'S DRAWING.

ALL DIMENSIONS, LEVELS, ETC ARE TO BE CHECKED BEFORE ANY WORK IS COMMENCED AND ANY DISCREPANCIES NOTED TO BE BROUGHT TO THE ARCHITECT'S ATTENTION.

ONLY FIGURED DIMENSIONS TO BE USED, SCALING OF DRAWINGS IS NOT ADVISABLE.

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GEOTECH INFORMATION

SOIL TYPE: H2/R and Unified Soil Class (SC-CL)

ASSUMED SOIL BEARING CAPACITY: ~150 kPa

RECOMMENDED FOUNDATION TYPE: Stiffened Soil Raft

RECOMMENDED FOUNDATION DEPTH: 0.8-1m

REV. NO. DATE DESCRIPTION

A	2020-12-16	FIRST ISSUE
B	2021-02-25	ISSUED FOR TENDER
C	2021-03-31	ISSUED FOR TENDER
D	2021-04-19	ISSUED FOR TENDER

MUNICIPAL APPROVAL

NAME:.....

SIGNATURE:.....DATE:.....

STAMPS:

PRINCIPAL AGENT



No. 1 Newtown Avenue, Killarney, Johannesburg, 2193

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Email: info@mamadi.co.za

COMPETENT CONTACT PERSON: CONT. No: +2711 532 8659

FULL NAME FIRM REG No: 2016/012437/07

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education

Lefapha la Thuto la Bokone Bophirima
Noord-Wes Departement van Onderwys
North West Department of Education
NORTH WEST PROVINCE

DISCIPLINE

ARCHITECTURAL

PROJECT NAME

D.P. KGOTLENG PRIMARY SCHOOL

EMIS NUMBER:
600103259

PROJECT STATUS

STAGE 1-3	STAGE 4	STAGE 5-6
CONCEPT	TENDER	CONSTRUCTION

DESCRIPTION

ADMIN BLOCK
- Ceiling Plan
- Roof Plan

SCALE:

1:50
1:100

DRAWN:

NAME OF COMPETENT PERSON:

ANDRE NKUNA

CHECKED:

NAME OF COMPETENT PERSON:

DANNY KALOMBO

REG No:

SIGNATURE

REG No: PR.ARCH24740538

SIGNATURE

PROJECT NUMBER

RFP 261/2019


DATE: 2020-12-15

DWG No: 107


OCCUPANCY CLASSIFICATION

G1 Offices

REV No: D

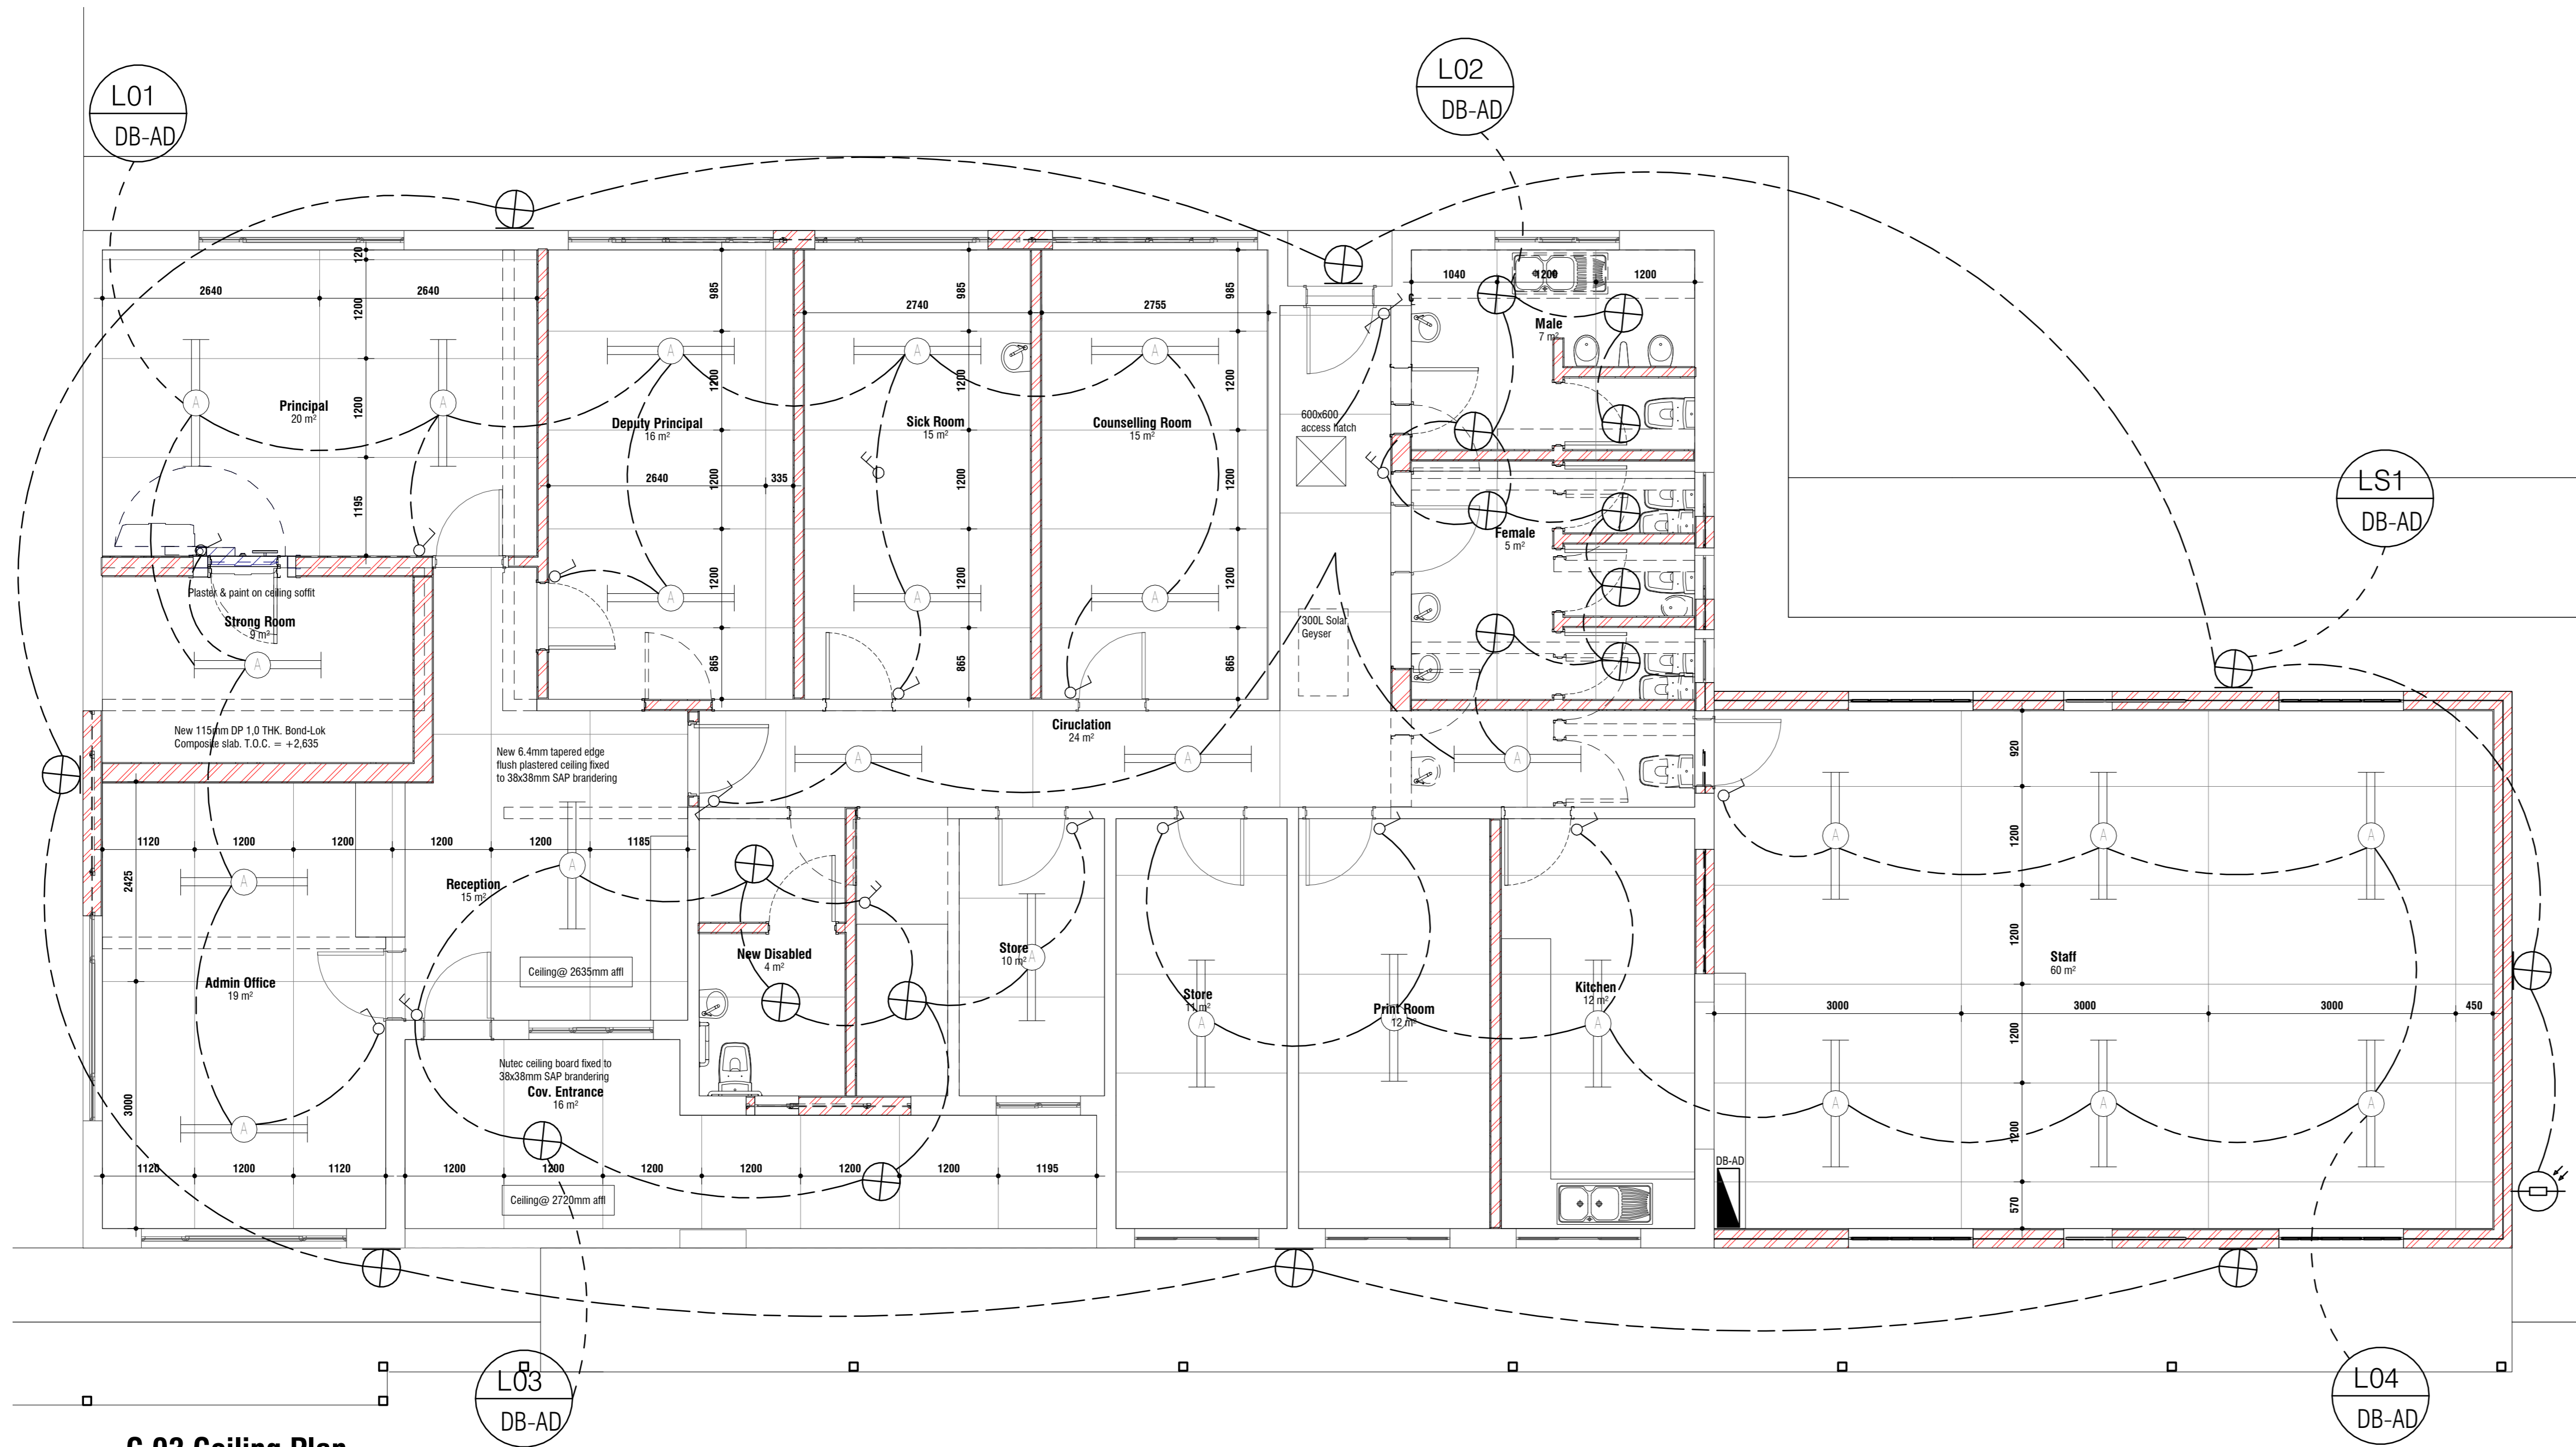

C 03 Ceiling Plan
SCALE: 1 : 50

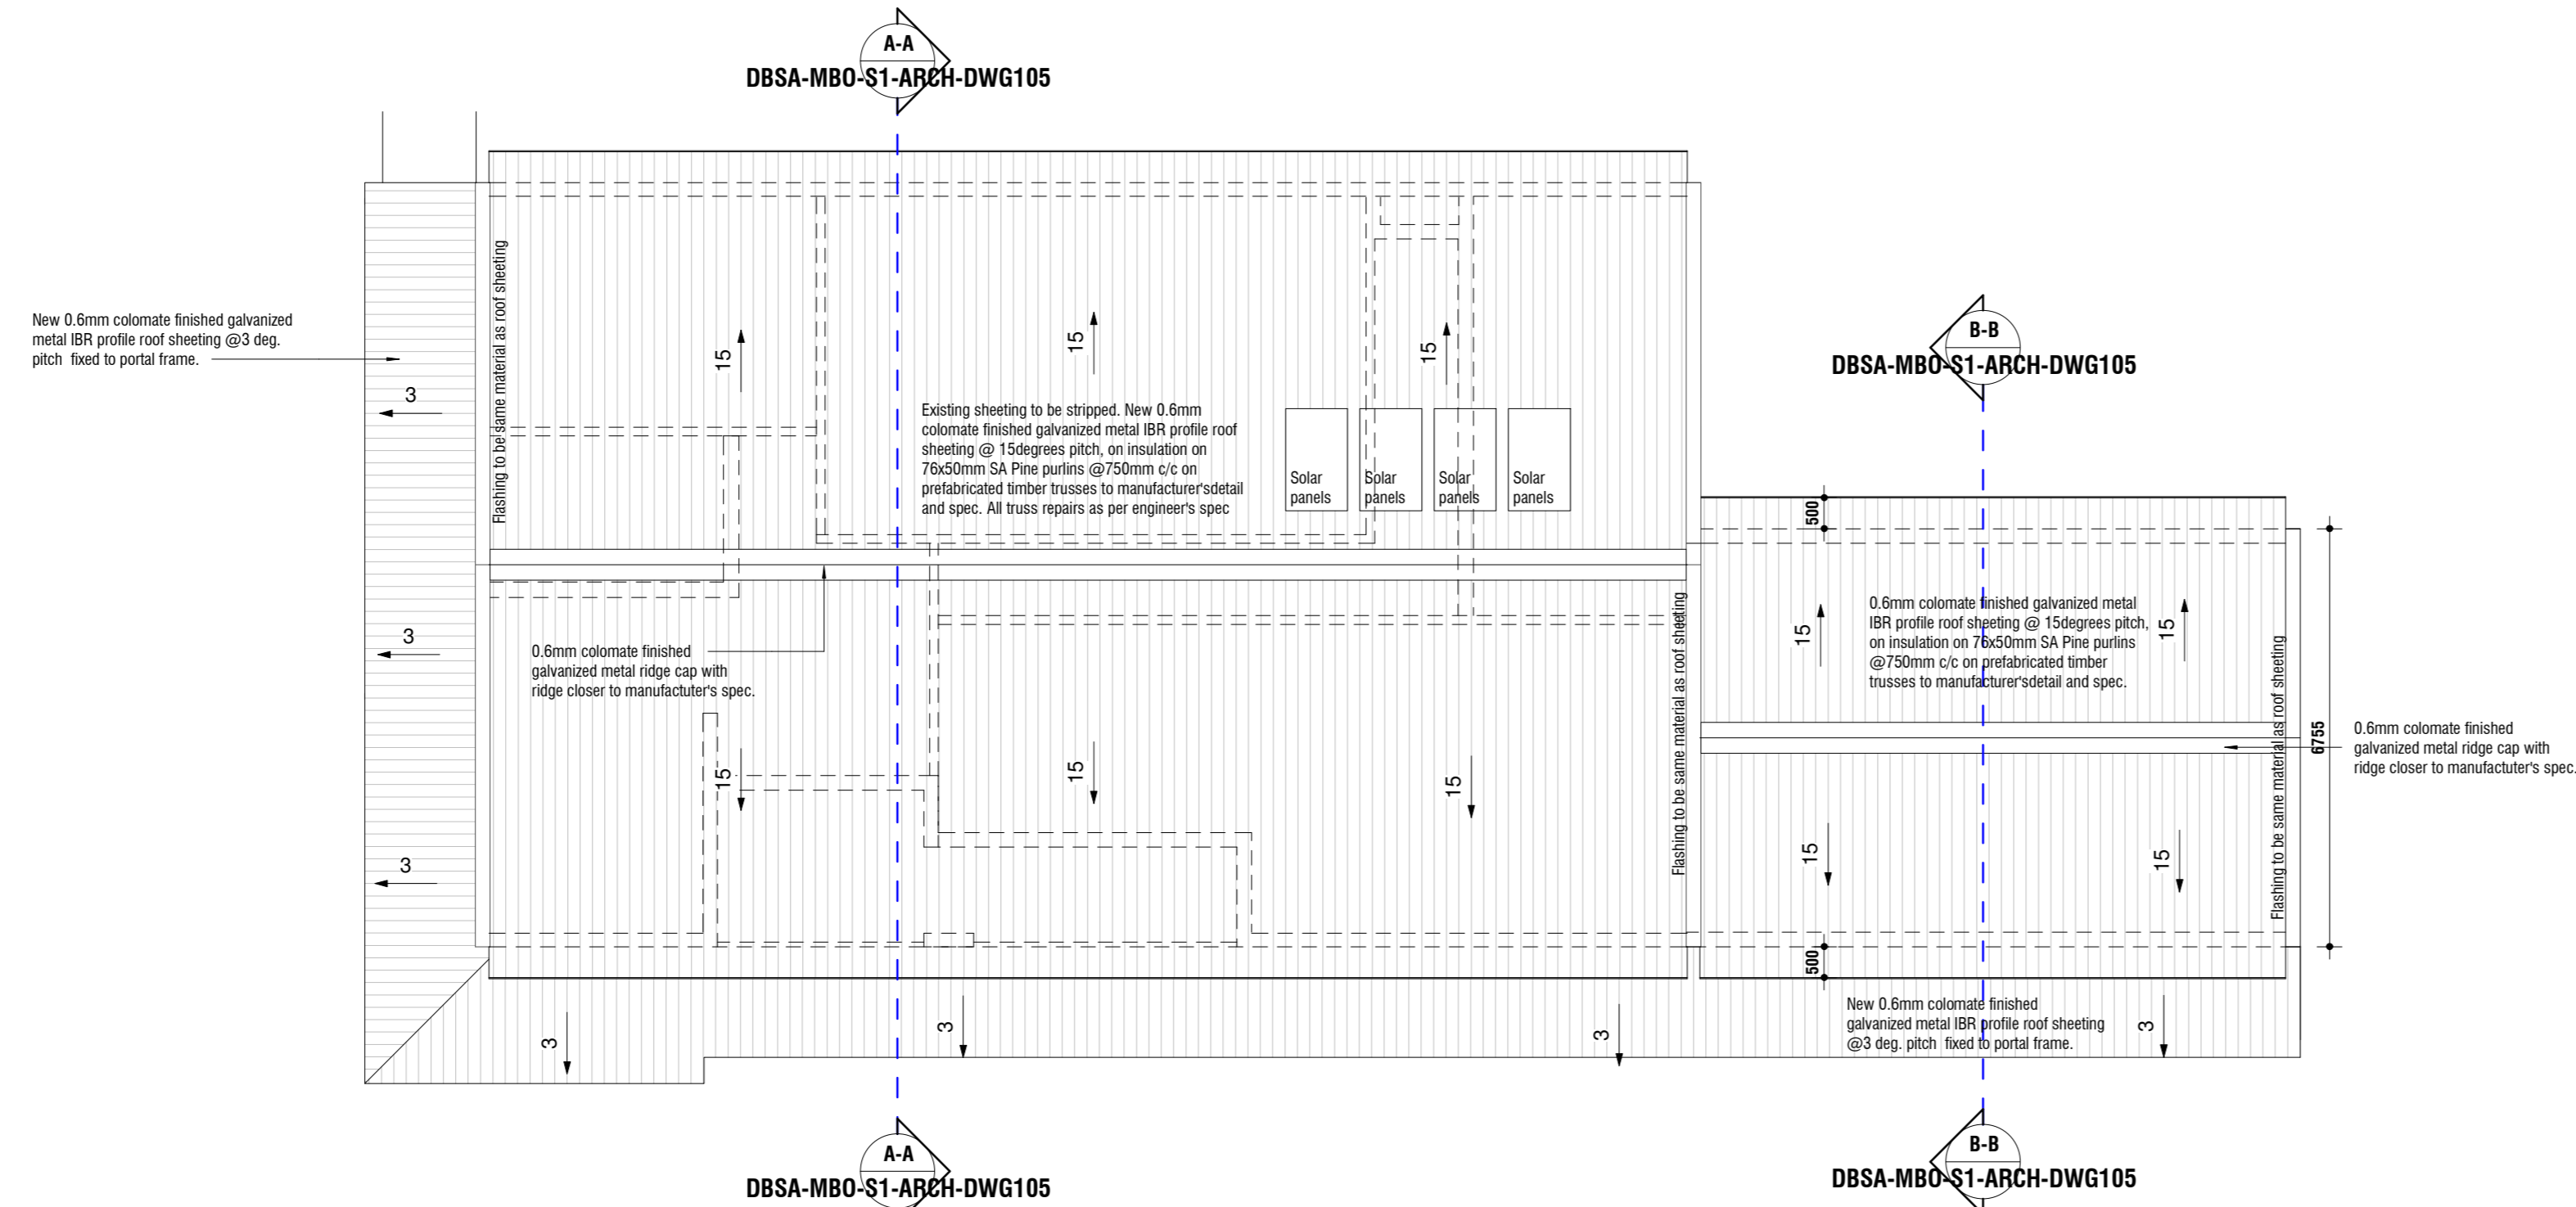

C 02 Roof Plan
SCALE: 1 : 100

LEGEND	
SYMBOLS	DESCRIPTION
	Type C - Surface mounted black round Bulkhead luminaire with polycarbonate lens and aluminium base complete with 2x5W LED (Similar to Lascos B10)
	Type C - Wall mounted black round Bulkhead luminaire with polycarbonate lens and aluminium base complete with 2x5W LED (Similar to Lascos B10)
	Type A - Commercial Open Channel fluorescent luminaire fitted with 2 x 58W tubes and electronic ballast with recessed holder
	Type E - Vapor proof fluorescent luminaire fitted with 2 x 58W tubes and electronic ballast with telescopic holders
	16A round 3 pin switch socket outlet surface mounted at 300mm AFFL
	16A round 3 pin switch socket outlet surface mounted at 1400mm AFFL
	16A Double round 3 pin switched socket outlet surface mounted 300mm AFFL
	16A Double round 3 pin switched socket outlet surface mounted 1400mm AFFL
	Data point
	Telephone point
	Distribution board
	Photocell
	One way switch 1400 AFFL
	Two way switch 1400 AFFL
	Double pole one way switch 1400 AFFL
	Single Phase Isolator
	Circuit identification (C) = Circuit Number (A/N) = DB Name (Ind from Normal Supply)
NOTES:	
1. ALL WORK TO BE CARRIED OUT IN ACCORDANCE WITH SANS 10142-1 SPECIFICATION.	
2. FINAL POSITIONS OF LUMINAIRES AND SOCKET OUTLETS TO BE DETERMINED ON SITE.	
3. BULKHEAD LUMINAIRES ARE TO BE MOUNTED AT A MINIMUM HEIGHT OF 2200mm ABOVE WALKWAYS UNLESS OTHERWISE STATED.	
4. LIGHT SWITCHES TO BE POSITIONED AT 1400mm AFFL. SWITCH TO BE POSITIONED CLOSE TO THE DOOR, BUT SUCH THAT AN OPENING DOOR DOES NOT OBSTRUCT THE SWITCH OPERATION.	
5. SWITCHED SOCKET OUTLETS TO BE INSTALLED AT MINIMUM 300mm ABOVE FINISHED SURFACE UNLESS STATED OTHERWISE.	
6. ISOLATORS SHALL BE INSTALLED IN CLOSE PROXIMITY TO THEIR RESPECTIVE UNITS.	

Architectural Legend	
Plan View	
	Existing Brickwork
	New brickwork
	60mm interlocking pavers
	New adjacent building
	Existing adjacent building
	Grass
	Road shading
Section View	
	Existing Brickwork
	New brickwork
	Existing concrete
	New concrete
Elevation View	
	Handbrick in Elevation
	Roof shading
	Plaster & Paint (colors may differ)

DBSA
ARCHITECT:.....
SIGNATURE:.....DATE:.....
OHS:.....
SIGNATURE:.....DATE:.....

NORTH WEST DEPARTMENT OF EDUCATION
NAME:.....
SIGNATURE:.....DATE:.....
NAME:.....
SIGNATURE:.....DATE:.....
NAME:.....
SIGNATURE:.....DATE:.....

SANS 10400 & XA COMPLIANCE
CONDUTANCE
SOLAR HEAT GAIN
GEOGRAPHICAL ZONE
NBRs COMPLIANCE
SITE PLAN
OTHER DRAWINGS

OTHER APPROVALS
Environmental Impact Assessment (EIA)
South African Heritage Resources Agency (SAHRA)
Department of Water and Sanitation (DWS)
South African National Roads Agency (SANRAL)
Other

WATER SUPPLIER
MUNICIPALITY
BOREHOLE
PRESSURE
TANKS
OTHER STORE

SANITATION/ SEWER
MUNICIPALITY
SEPTIC TANKS
PIT LATRINES
OTHER

SITE INFORMATION
ERF No.
COVERAGE
VILLAGE NAME
DISTRICT
COORDINATES

STAGES
SIPDM
SACAP
Mark with X

PROJECT TEAM
COMPETENT CONTACT PERSON
CONTACT No.
REGISTRATION No.
COMPANY NAME
ARCHITECT
Q. SURVEYOR
STRUCT. ENG
CIVIL ENG
MECH. ENG
ELECT. ENG
OHS
CONTRACTOR