




C 03 Ceiling Plan  
SCALE: 1 : 50

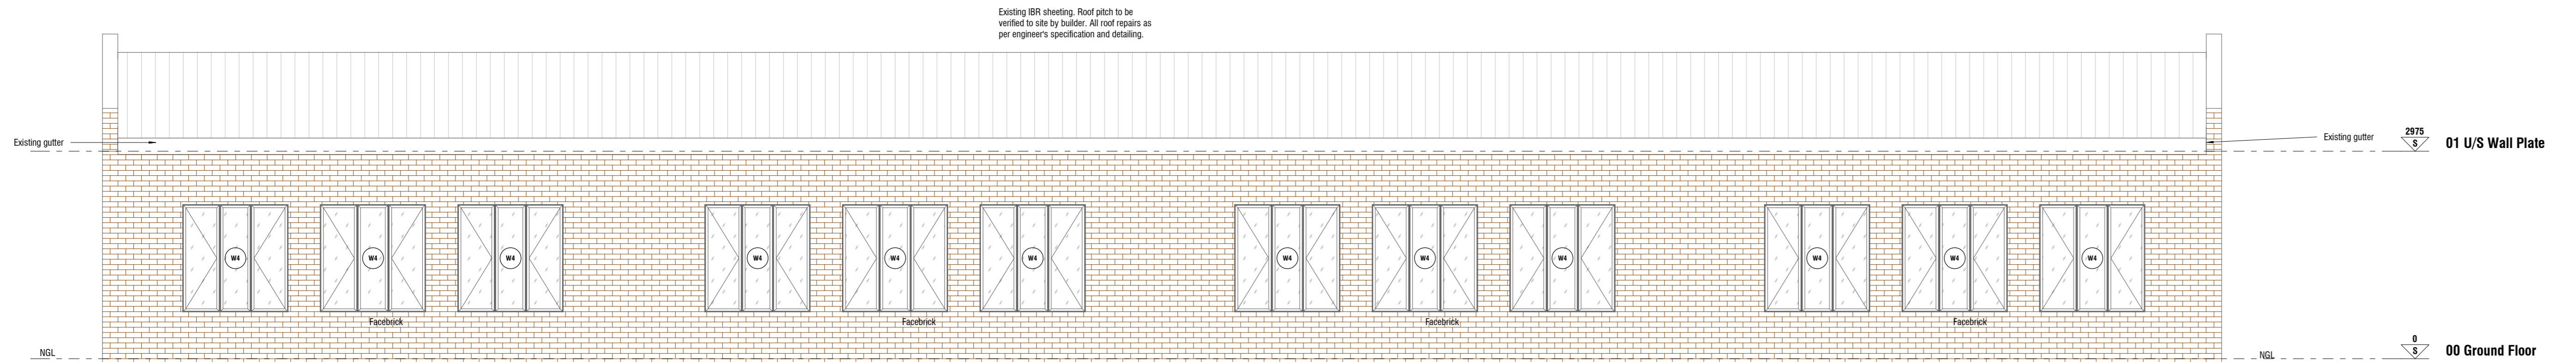


C 30 Rear Elevation  
SCALE: 1 : 50

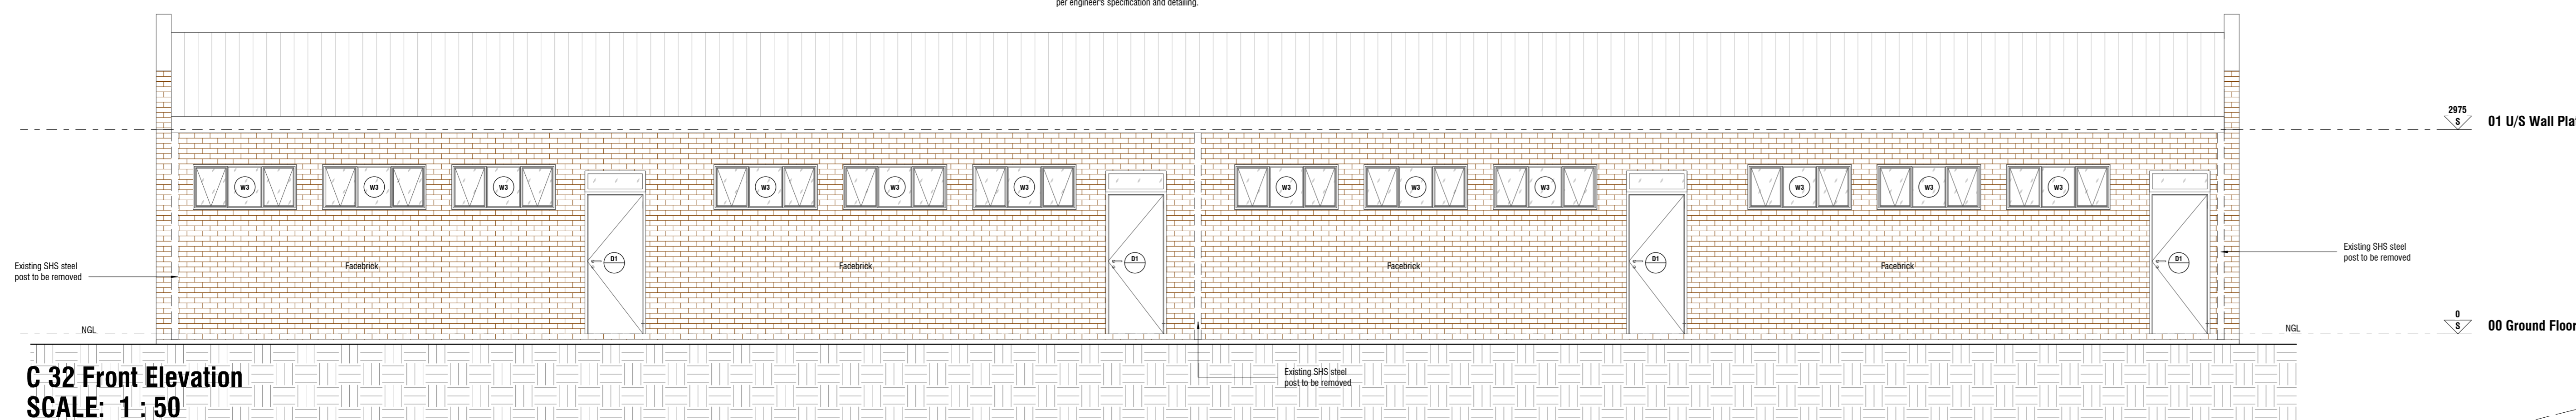


C 32 Front Elevation  
SCALE: 1 : 50

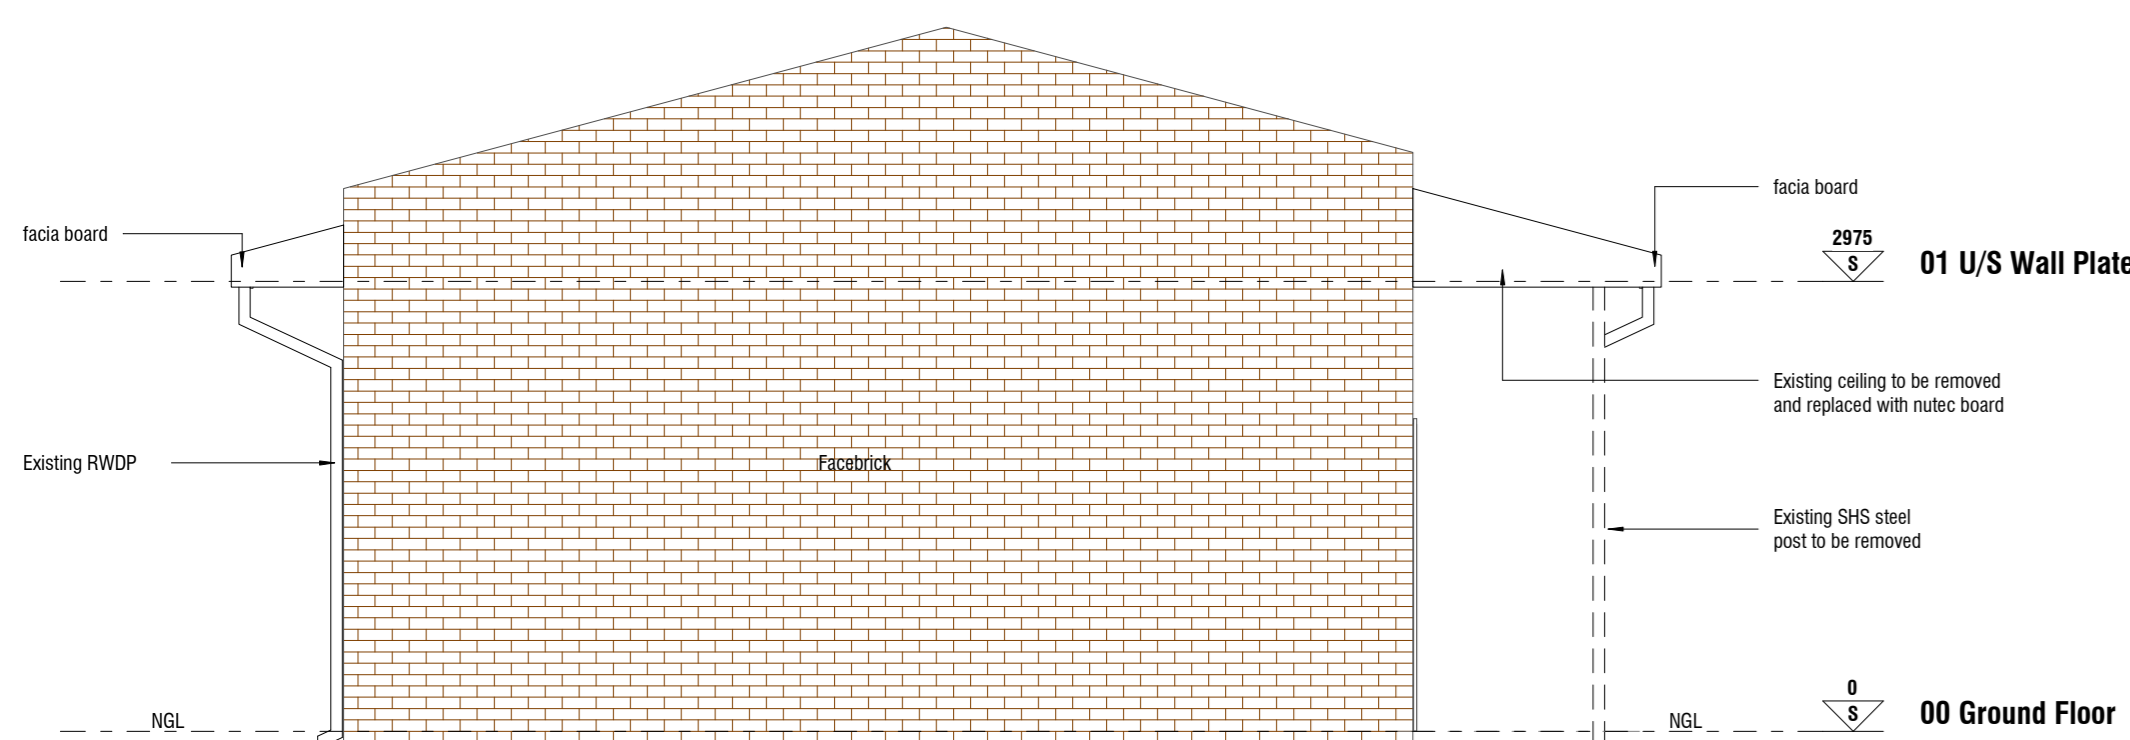

C 33 Side Elevation 2  
SCALE: 1 : 50

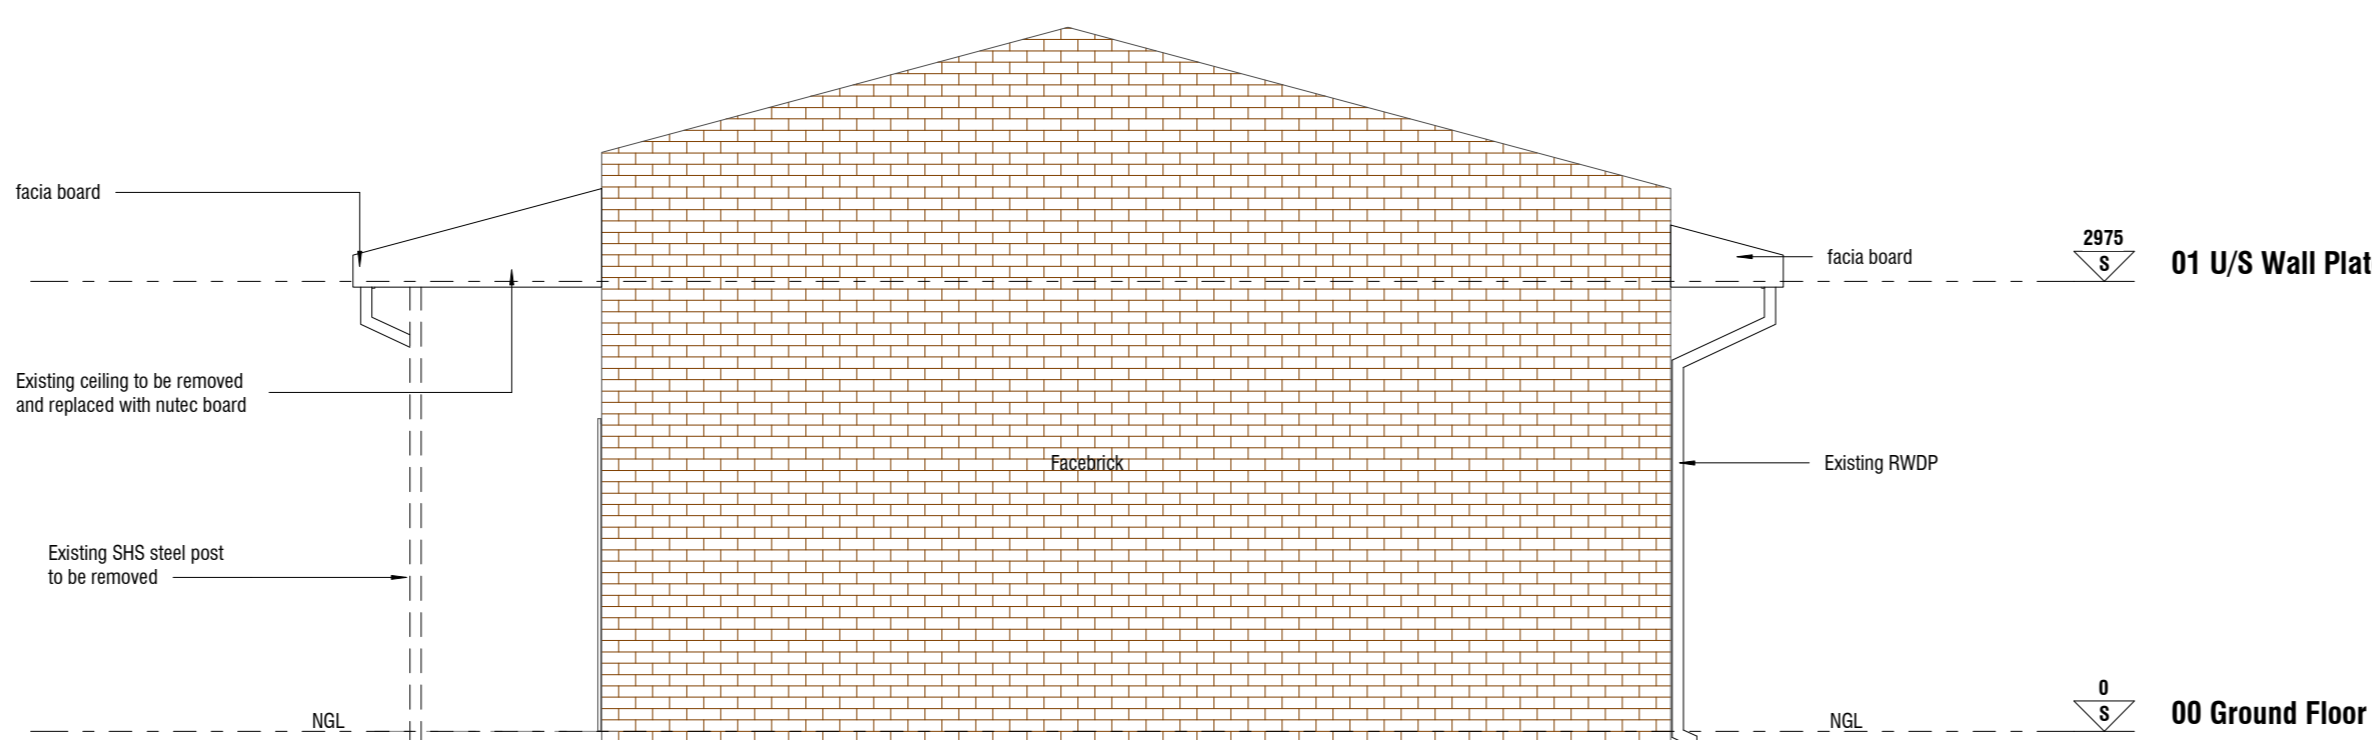

C 31 Side Elevation 1  
SCALE: 1 : 50

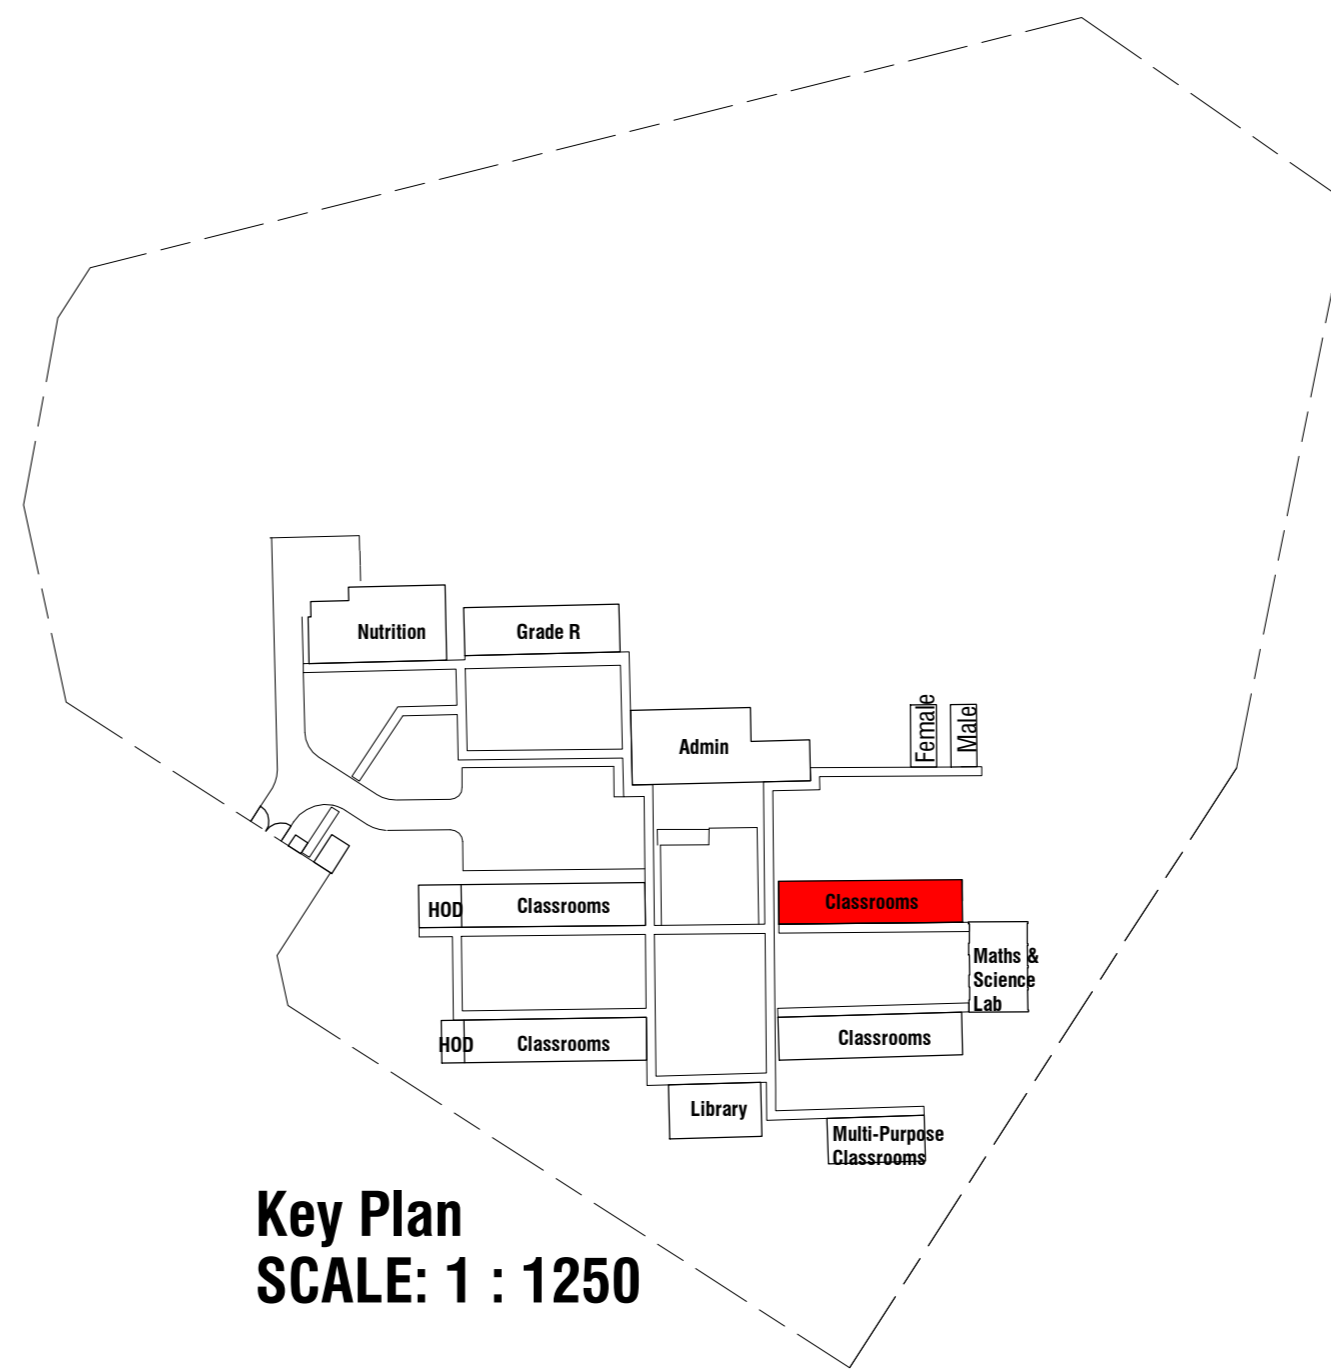

Key Plan  
SCALE: 1 : 1250

LEGEND	
SYMBOLS	DESCRIPTION
	Type C - Surface mounted black round bulkhead luminaire with polycarbonate lens and aluminum base complete with 250W lamp ( Refer to Locom B10)
	Type C - Wall mounted black round bulkhead luminaire with polycarbonate lens and aluminum base complete with 250W lamp ( Refer to Locom B10)
	Type E - Vapour proof fluorescent luminaire fitted with 2 x 58W tubes and electronic ballast with telescopic hangers. (All lighting to have protection cover for channels)
	16A round 3-pin switch socket outlet surface mounted at 300mm AFPL
	16A round 3-pin switch socket outlet surface mounted at 1400mm AFPL
	16A Double Inward 3-pin switched socket outlet surface mounted 300mm AFPL
	16A Double Inward 3-pin switched socket outlet surface mounted 1100mm AFPL
	Data point
	Telephone point
	Distribution board
	Photocell
	One way switch 1400 AFPL
	Two way switch 1400 AFPL
	Double pole one way switch 1400 AFPL
	Single Phase Isolator
	Circuit identification 01 = Circuit Number A/N = DB Name (Not from Normal Supply)
<b>NOTES:</b> 1. ALL WORK TO BE CARRIED OUT IN ACCORDANCE WITH SANS 10142-1 SPECIFICATION. 2. FINAL POSITIONS OF LUMINAIRES AND SOCKET OUTLETS TO BE DETERMINED ON SITE. 3. BULKHEAD LUMINAIRES ARE TO BE MOUNTED AT A MINIMUM HEIGHT OF 2200mm ABOVE WALKWAYS UNLESS OTHERWISE STATED. 4. LIGHT SWITCHES TO BE POSITIONED AT 1400mm AFPL. SWITCH TO BE POSITIONED CLOSE TO THE DOOR, BUT SUCH THAT AN OPENING DOOR DOES NOT OBSTRUCT THE SWITCH OPERATION. 5. SWITCHED SOCKET OUTLETS TO BE INSTALLED AT MINIMUM 300mm ABOVE FINISHED SURFACE UNLESS STATED OTHERWISE. 6. ISOLATORS SHALL BE INSTALLED IN CLOSE PROXIMITY TO THEIR RESPECTIVE UNITS.	



#### GENERAL NOTES

THIS DRAWING IS TO BE READ IN CONJUNCTION WITH ALL RELEVANT ARCHITECT'S AND ENGINEER'S DRAWING.

ALL DIMENSIONS, LEVELS, ETC ARE TO BE CHECKED BEFORE ANY WORK IS COMMENCED AND ANY DISCREPANCIES NOTED TO BE BROUGHT TO THE ARCHITECT'S ATTENTION.

ONLY FIGURED DIMENSIONS TO BE USED, SCALING OF DRAWINGS IS NOT ADVISABLE.

ALL RIGHTS RESERVED. NO PART OF THIS DESIGN SHALL BE REPRODUCED, USED ELSEWHERE AND/ OR IN ANY WAY WITHOUT PRIOR PERMISSION FROM THE ARCHITECT/ ENGINEER.

#### GEOTECH INFORMATION

SOIL TYPE: H2/R and Unified Soil Class (SC-CL)

ASSUMED SOIL BEARING CAPACITY: ~150 kPa kPa

RECOMMENDED FOUNDATION TYPE: Stiffened Soil Raft

RECOMMENDED FOUNDATION DEPTH: 0.8-1m

REV. NO.	DATE	DESCRIPTION
A	2020-12-16	FIRST ISSUE
B	2021-02-25	ISSUED FOR TENDER
C	2021-03-31	ISSUED FOR TENDER
D	2021-04-19	ISSUED FOR TENDER

#### MUNICIPAL APPROVAL

NAME:.....

SIGNATURE:.....DATE:.....

STAMPS:

PRINCIPAL AGENT



No. 1 Newtown Avenue, Killarney, Johannesburg , 2193

Tel: 011 - 532 8659  
Email: info@mamadi.co.za

COMPETENT CONTACT PERSON: CONT. No: +2711 532 8659

FULL NAME FIRM REG No: 2016/012437/07

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DISCIPLINE

#### ARCHITECTURAL

PROJECT NAME

D.P. KGOTLENG PRIMARY SCHOOL

EMIS NUMBER: 600103259

PROJECT STATUS

STAGE 1-3	STAGE 4	STAGE 5-6
CONCEPT	TENDER	CONSTRUCTION

DESCRIPTION

EXISTING CLASSROOM BLOCKS 1:50  
- Ceiling Plan 1:100  
- Elevation

DRAWN: NAME OF COMPETENT PERSON: ANDRE NKUNA  
CHECKED: NAME OF COMPETENT PERSON: DANNY KALOMBO

REG No: SIGNATURE: PROJECT NUMBER: RFP 261/2019  
DATE: 2020-12-15  
DWG No: 116

OCCUPANCY CLASSIFICATION  
A4.4 Primary & Secondary School  
REV No: D

#### SANS 10400 & XA COMPLIANCE

CONDUTANCE	Rational Des. [Y] [N] Standard Cal [Y] [N]
SOLAR HEAT GAIN	Rational Des. [Y] [N] Standard Cal [Y] [N]
GEOGRAPHICAL ZONE	
NBRs COMPLIANCE	Yes No
SITE PLAN	Yes No
OTHER DRAWINGS	Yes No

#### OTHER APPROVALS

Environmental Impact Assessment (EIA)	Mark with X Yes No N/A
South African Heritage Resources Agency (SAHRA)	Mark with X Yes No N/A
Department of Water and Sanitation (DWS)	Mark with X Yes No N/A
South African National Roads Agency (SANRAL)	Mark with X Yes No N/A
Other	Mark with X Yes No N/A

#### WATER SUPPLIER

MUNICIPALITY	Yes No MUNICIPALITY NAME: Mafikeng
BOREHOLE	Yes No WATER USE LICENCE: Not Available
PRESSURE	TBC BARS
TANKS	Number Total Capacity: 1 2000 LITERS
OTHER STORE	Yes No SPECIFY: Specify below

#### SANITATION/ SEWER

MUNICIPALITY	Yes No MUNICIPALITY NAME: Mafikeng
SEPTIC TANKS	Yes No CAPACITY: MS
PIT LATRINES	Yes No
OTHER	Yes No SPECIFY: Specify below

#### SITE INFORMATION

ERF No.	747
COVERAGE	9.6 % (3442 m²)
VILLAGE NAME	Mmabatho Unit 2
DISTRICT	Ngaka Modiri Molema
COORDINATES	25°50'15.5"S 25°35'29.7"E

#### STAGES

SIPDM	SACAP	Mark with X
0		
1		
2		
3	1	
4	2	
5	3	
6	4	
7	5	
8	5	
9	6	

#### PROJECT TEAM

	COMPETENT CONTACT PERSON	CONTACT No.	REGISTRATION No.	COMPANY NAME
ARCHITECT	DANNY KALOMBO	+27 79 875 8873	PR.Arch 24740538	MAMADI & COMPANY
Q. SURVEYOR	HENK DOKTER	+27 82 807 9005	570 - SQCS	MAMADI & COMPANY
STRUCT. ENG	THABISO MOTSHEGOA	+27 73 757 8094	201370184 - ECSA	MAMADI & COMPANY
CIVIL ENG	GIVEN MBHOKOTA	+27 83 580 1709	201470013 - ECSA	MAMADI & COMPANY
MECH. ENG	PULE SHEANE	+27 72 172 8396	201570022 - ECSA	MAMADI & COMPANY
ELECT. ENG	JOHN MOKOENA	+27 63 005 5891	20030038 - ECSA	MAMADI & COMPANY
OHS	NATHANIEL MATHAGA	+27 72 947 7939	CHS 1400005	MAMADI & COMPANY
CONTRACTOR				