



1. FOR GENERAL NOTES REFER TO DRAWING DIMENSIONS TO BE VERIFIED ON SITE PRIOR TO COMMENCEMENT OF WORKS. ANY DISCREPANCIES TO BE BROUGHT TO THE ENGINEERS ATTENTION IMMEDIATELY . THIS DRAWING IS TO BE READ IN CONJUNCTION WITH ALL OTHER DRAWINGS, SCHEDULES AND SPECIFICATIONS RELATED TO THIS PROJECT. 4. ALL BUILDING WORK AND MATERIALS ARE TO COMPLY WITH

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REGULATIONS

WATER METER BALANCING VALVE

ISOLATING VALVE

PIPE CONNECTION PIPE RISER PIPE DROPPER

FW - FIRE WATER

HWS - HOT WATER SUPPLY ------ HWR - HOT WATER RETURN ----- CW - COLD WATER

MIXING VALVE

2 2022/03/08 REVISED TO ARCHITECTS PLAN JMN

CLIENT DEPARTMENT SIGNATURES FACILITY STAMP

FACILITY MANAGER

INFRASTRUCTURE

GENERAL MANAGER

MANAGER

Stamped by Plans Approval Commitee

Approved as coordination services by Principal Agent

Education and Sport Development

Department of Education and Sport Development
Department van Onderwys en Sportontwikkeling
Lefapha la Thuto le Tihabololo ya Metshameko



UKUZA CONSULTING (PTY) LTD Westville
Durban
Tel: (031) 266-7861

Mechanical Engineers
Dihlase Consulting Engineers
4 Rockdale Avenue Email: dbn@dihlase.co.za

MECHANICAL

PROJECT NAME: KGOSI SHOPE

SECONDARY SCHOOL


OVERALL DOMESTIC WATER PLAN

REF NO: D3888 **DESIGNED BY:** Z VORAGEE DRAWN BY: JM NUGENT SCALE: CHECKED BY: R ISMAIL

D3888-DW-A1-00


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FOR CONSTRUCTION

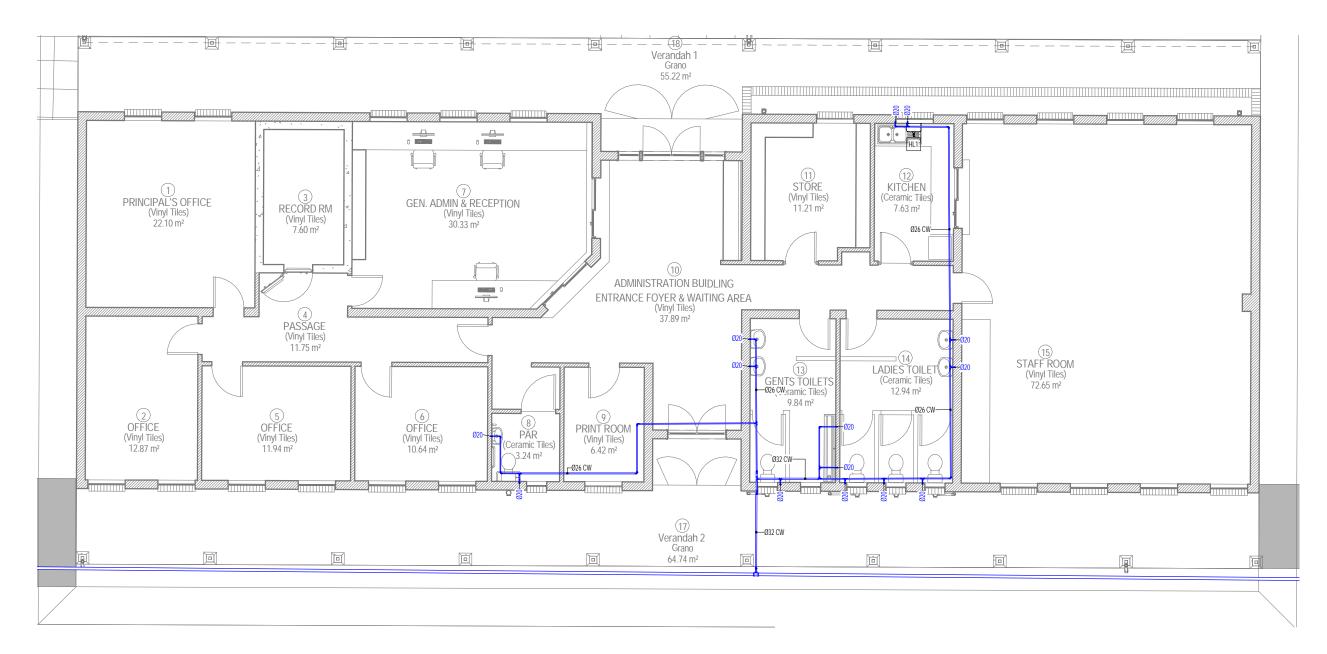


01-ADMIN BLOCK (DW)


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01-KITCHEN & DINNING (DW)

1:100

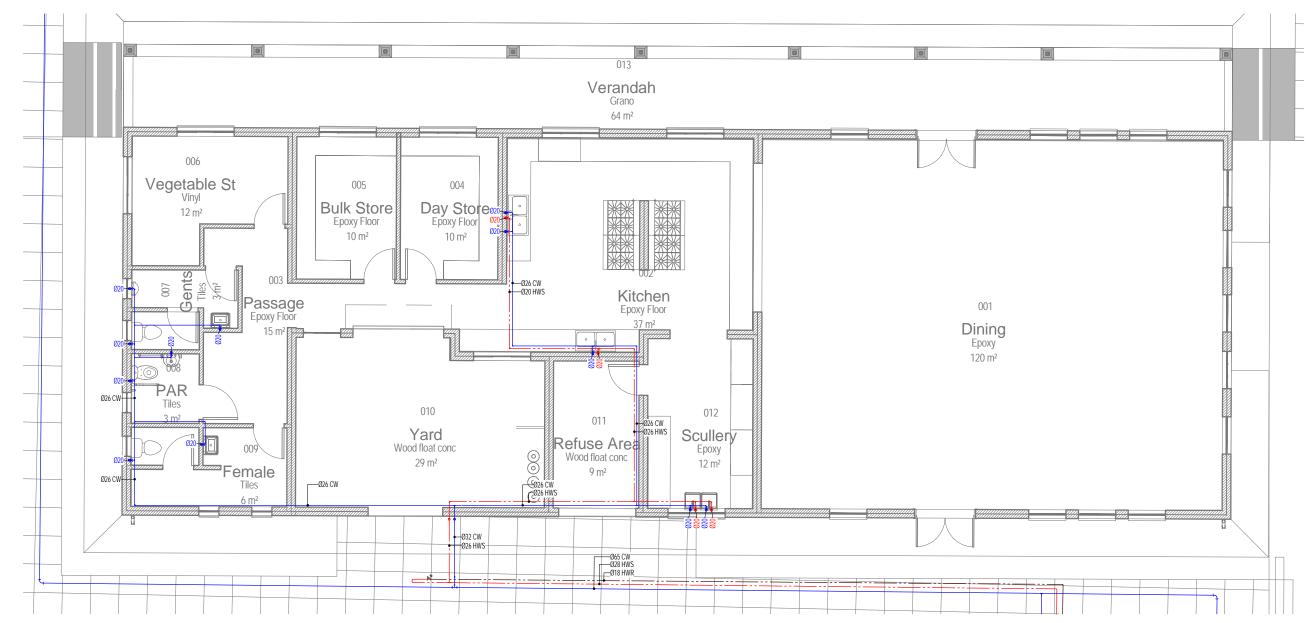

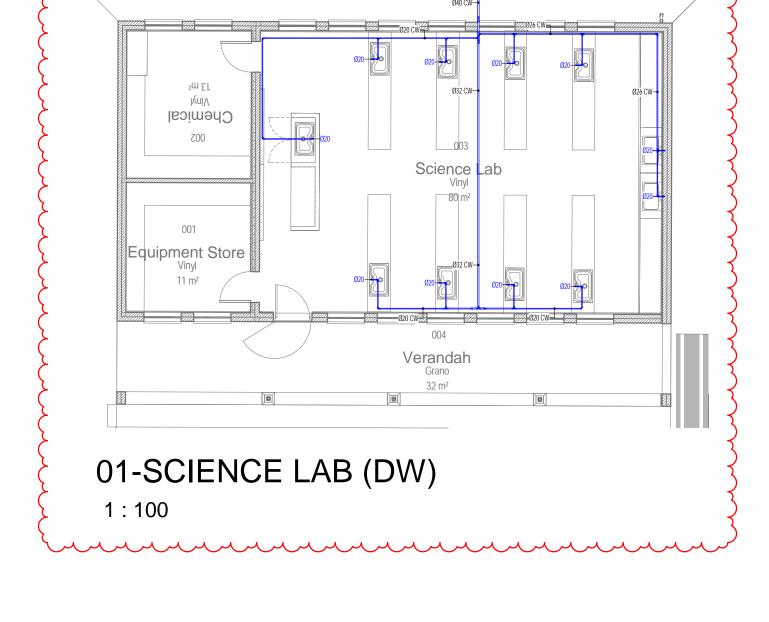

01-GUARD HOUSE (DW)

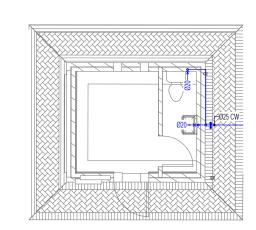1:100

			Equipment Schedule			
Tag	Name	Model	Discription	Manufacturer	Size	Qty
HL1	Hydroboil	ZIP HYDRO	Supply and installed by contractor	ZIP or other approved	5 Litre	1

NOTES

- All H&C water external pipework to be Multi-layer Mepla with Gerbent RED & BLUE Lagging.
 All pipeworks chased in walls to be Multi-layer Mepla.
 All hot water pipework chased in wall to be Gerbent Mepla with Gerbent Red Lagging.
- Gerbent Mepla with Gerbent Red Lagging. specification (Gerbent Red & Blue Lagging).

 5 All fire pipework above ground to be medium black & painted with red oxide. Pipework to be in accordance with SABS 62-1 or SABS 62-2 or both. Fittings to be SABS 815

 6 All cold water underground pipework to be Class 10 polyethylene. Piping to be SABS 966.

WATER METER

BALANCING VALVE

966. 7 All geyser hot water by heat pumps.

LEGEND

\bowtie	ISOLATING VALVE
	MIXING VALVE
×	PIPE CONNECTION
S	PIPE RISER
Θ	PIPE DROPPER
	HWS - HOT WATER SUPPLY
	HWR - HOT WATER RETURN
	CW - COLD WATER
	FW - FIRE WATER

PRELIMINARY

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FOR TENDER PURPOSES

FOR CONSTRUCTION

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FΑ	CILITY ST	AMP	
FΔ	CILITY MA	NAGER	
. , ,	OILII I WII	WIGER	
INIT	FRASTRUC	TUDE	
		JIUKE	
IVI <i>P</i>	NAGER		



GENERAL

MANAGER





UKUZA CONSULTING (PTY) LTD

CONSULTANTS DETAILS:

Mechanical Engineers

Dihlase Consulting Engineers

4 Rockdale Avenue

Westville

Durban

Tel: (031) 266-7861 Fax: 0867605088

Email: dbn@dihlase.co.za



MECHANICAL

PROJECT NAME:

KGOSI SHOPE SECONDARY SCHOOL

SHEET TITLE:

DOMESTIC WATER PLANS

 DATE:
 REF NO:

 2022/03/08
 D3888

 PAPER SIZE:

 A1
 DESIGNED BY:

 Z VORAGEE

 SCALE:

 DRAWN BY:

 JM NUGENT

 CHECKED BY:

DRAWING NUMBER:

D3888-DW-A1-01

R ISMAIL

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12/03/08 18:05:40

LEGEND

WATER METER BALANCING VALVE ISOLATING VALVE

MIXING VALVE PIPE CONNECTION


PIPE DROPPER HWS - HOT WATER SUPPLY

----- HWR - HOT WATER RETURN CW - COLD WATER

FW - FIRE WATER


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- 7 All geyser hot water by heat pumps.

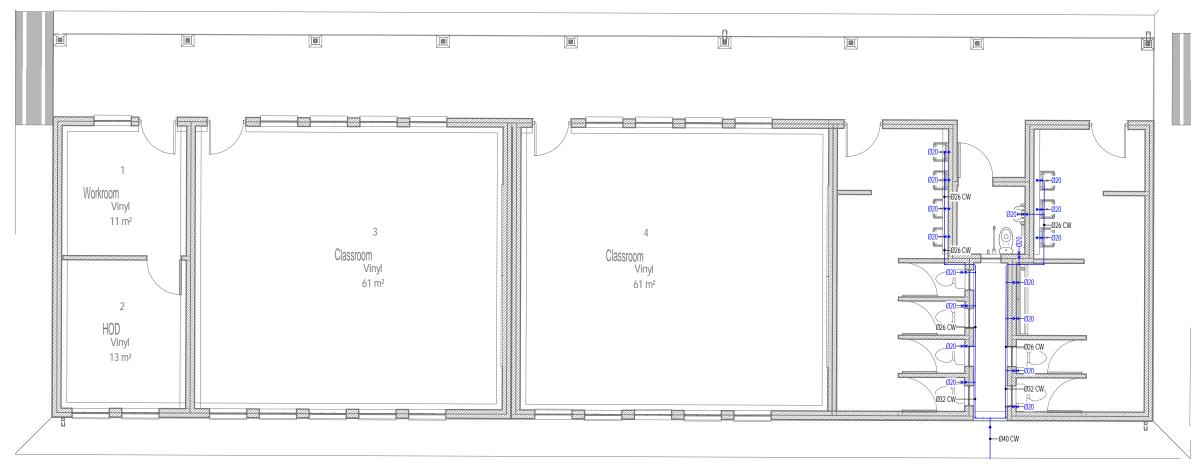


01-CL2 ABU (DW)

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01-CL3 ABU (DW)

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01-COMP & LIBRARY (DW)

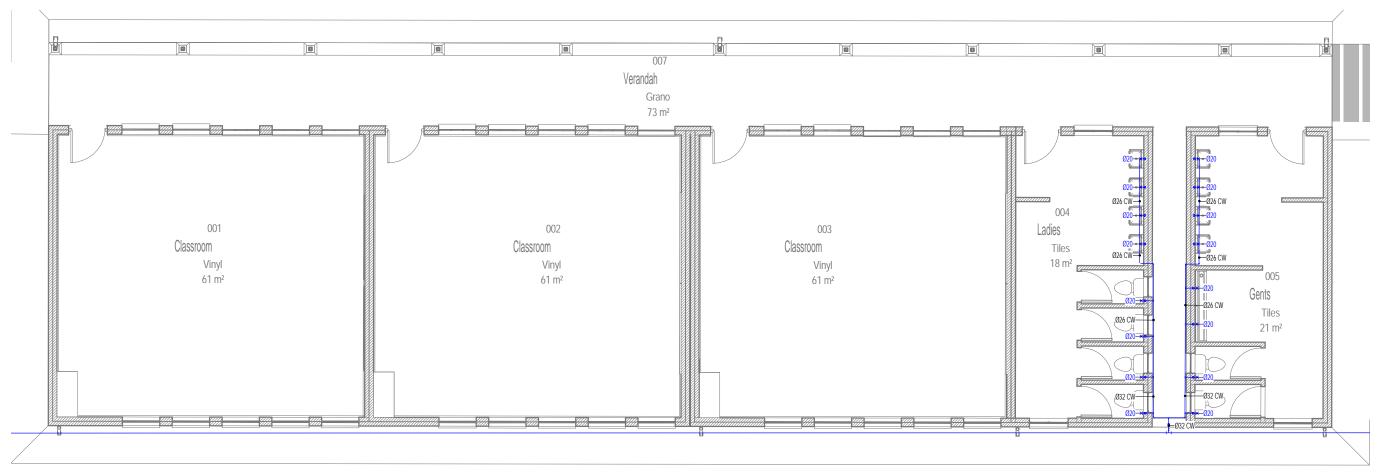1:100

NOTES:
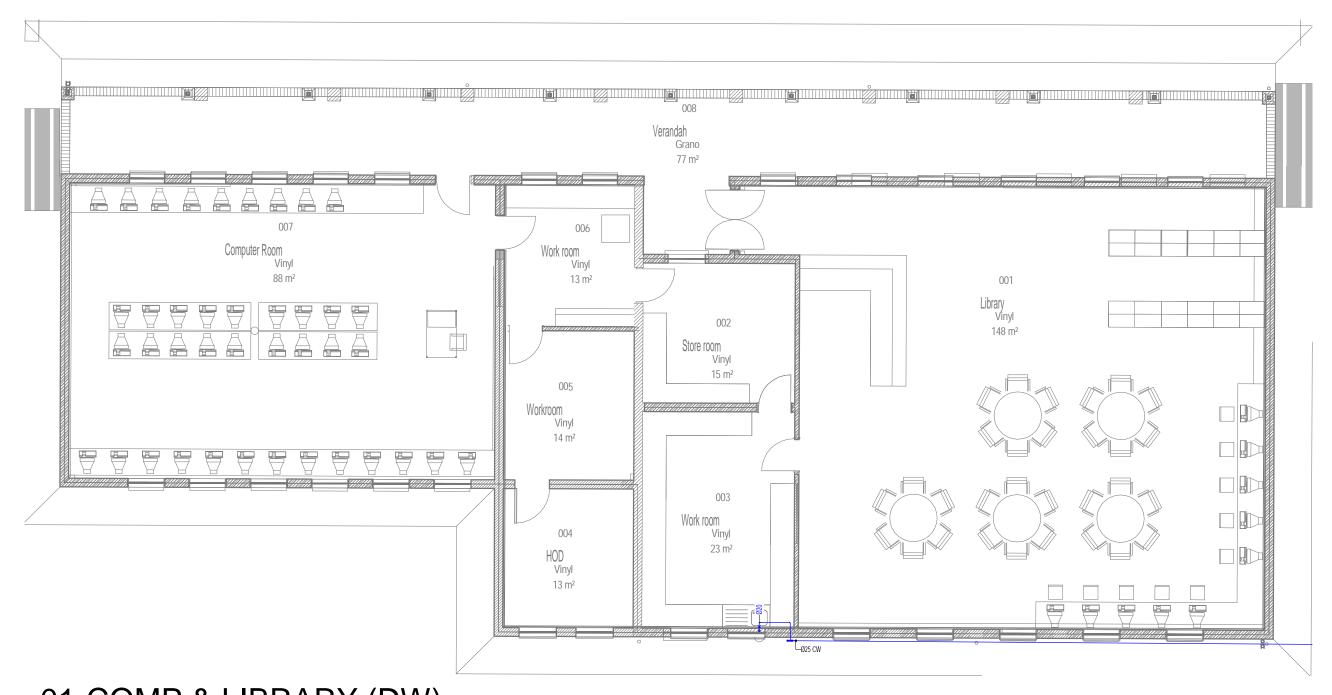
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10	DATE	DESCRIPTION	DRN BY
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CLIENT DEPARTMENT SIGNATURES

FACILITY STAMP

FACILITY MANAGER

INFRASTRUCTURE

MANAGER

GENERAL MANAGER

CLIENT NAME:



UKUZA CONSULTING (PTY) LTD

CONSULTANTS DETAILS: Mechanical Engineers Dihlase Consulting Engineers 4 Rockdale Avenue Westville Durban

Tel: (031) 266-7861 Fax: 0867605088 Email: dbn@dihlase.co.za

ARCHITECT DETAILS:



MECHANICAL

PROJECT NAME:

KGOSI SHOPE SECONDARY SCHOOL

DOMESTIC WATER PLANS

DATE: 2022/03/08 DESIGNED BY: Z VORAGEE DRAWN BY: JM NUGENT As indicated CHECKED BY: R ISMAIL

DRAWING NUMBER:

PRELIMINARY

FOR APPROVAL


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FOR TENDER PURPOSES

FOR CONSTRUCTION

D3888-DW-A1-02

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WATER METER

ISOLATING VALVE MIXING VALVE

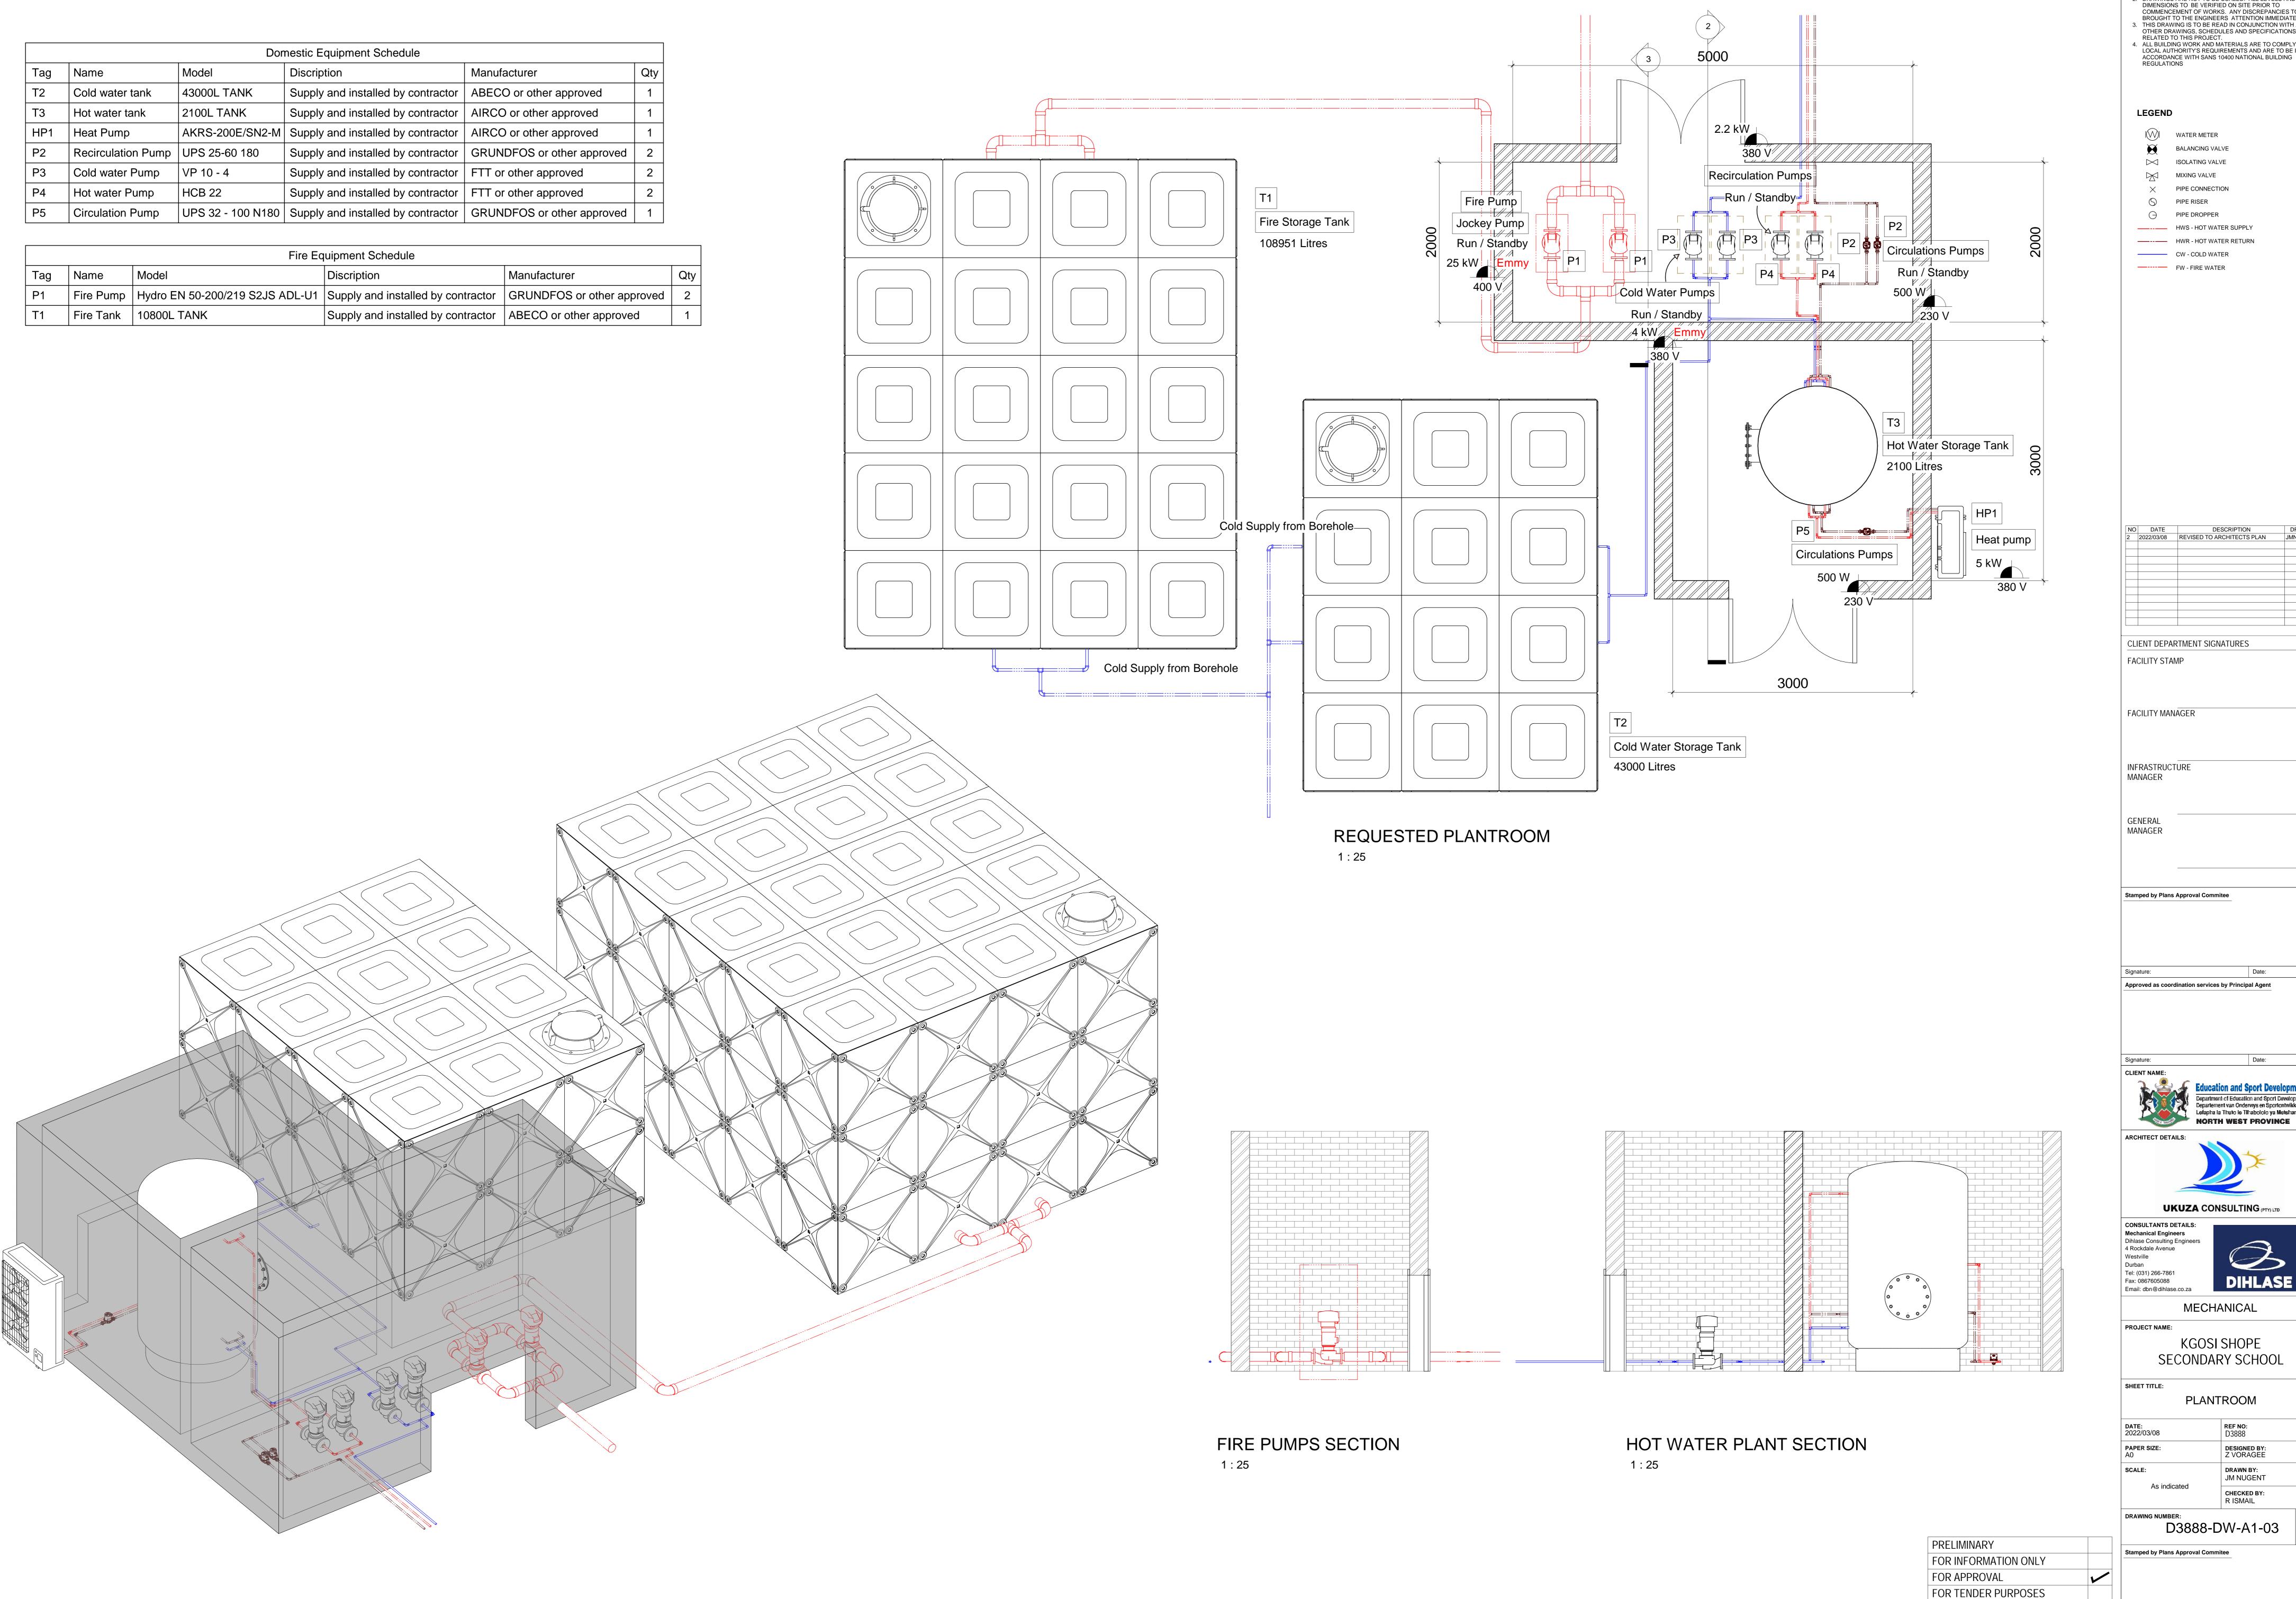PIPE CONNECTION PIPE RISER PIPE DROPPER

------ HWR - HOT WATER RETURN FW - FIRE WATER

 NO
 DATE
 DESCRIPTION
 DRN BY

 2
 2022/03/08
 REVISED TO ARCHITECTS PLAN
 JMN

CLIENT DEPARTMENT SIGNATURES

FACILITY STAMP

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UKUZA CONSULTING (PTY) LTD

Mechanical Engineers
Dihlase Consulting Engineers

MECHANICAL

KGOSI SHOPE SECONDARY SCHOOL

PLANTROOM

FOR CONSTRUCTION

JM NUGENT

D3888-DW-A1-03

FIRE FIGHTING EQUIPMENT FIRE ESCAPE & EQUIPMENT SIGNAGE SIGNAGE NOTES: LEGEND: • ALL SIGNAGE SHALL COMPLY WITH SABS 1186-1997 •SIGNS IN OFFICE ENVIRONMENT SHALL BE 190mm x 190mm MOUNTED AS INDICATED
•SIGNS IN EQUIPMENT ROOMS SHALL BE PHOTOLUMINESCENT 290mm x 290mm MODULES UNFRAMED SIGNAGE SIZE INDICATION AND DESCRIPTIONS: 30m Hose reel مال THE FOLLOWING CODES ARE USED TO INDICATE SIGNS AND SIZES AS FOLLOWS: •OUTDOOR SIGNS SHALL BE NON- PHOTOLUMINESCENT, WEATHER RESISTANT 290mm x 290mm MODULES UNFRAMED 4.5kg DCP Fire extinguisher E(W) EMERGENCY DIRECTIONAL •ALL SIGNS SHALL BE INSTALLED AT A STANDARDISED HEIGHT, SUITED TO LOCAL SITE CONDITIONS AND AT THE MOST CONSPICIOUS POSITIONS AVAILABLE F(W) FIRE EQUIPMENT EXPLANATION: Twin booster connection **METHOD OF FIXING:** F1 SIGNAGE SYMBOL AS INDICATED ON DRAWING W | WALL MOUNTED SIGNAGE • SUSPENDED SIGNS SHALL BE SUSPENDED WITH 3mm DIAM. PVC COATED CABLE & 20mm DIAM . KEYRINGS. 65mm fire hydrant A SIZE 190mm x 190mm S SUSPENDED SIGNAGE • WALL MOUNTED SIGNS SHALL BE FIXED AT ALL FOUR CORNERS WITH DOUBLE SIDED TAPE. B SIZE 290mm x 290mm T POLE MOUNTED SIGNAGE Sprinkler (Ceiling) • IN PASSAGES AND WALKWAYS, SIGNS TO BE PLACED AT 90 TO THE PASSAGE AND WALKWAY. D SIGNAGE MATERIAL HIGH IMPACT ACRYLIC H DOOR MOUNTED SIGNAGE • SUSPENDED SIGNS TO BE POSITIONED AT MIN. 2100mm CLEARANCE HEIGHT AND NOT WITHIN 500mm Sprinkler (Exposed) OF ANY AUTOMATIC FIRE SPRINKLER HEAD. SUSPENDED SIGNS TO BE INSTALLED AT A UNIFORM HEIGHT AND TO HAVE A MAXIMUM VIEWING DISTANCE OF 30m. P SIGNAGE MATERIAL PHOTO LUMINESCENT ACRYLIC X1 ELECTRICALLY ILLUMINATED EXIT SIGNAGE Sprinkler control valve F ALUMINIUM FRAMED SIGNAGE X2 SIGNAGE INDICATING CHANGE IN FLOOR LEVEL

ORIENTATION OF SIGNAGE SHOWN ON DRAWING IS INDICATIVE AS PER INSTALLATION



Tempary Buildings

	Equipment Schedule					
Tag	Name	Model	Discription	Manufacturer	Qty	
P1	Fire Pump	Hydro EN 50-200/219 S2JS ADL-U1	Supply and installed by contractor	GRUNDFOS or other approved	2	
T1	Fire Tank	108 000L TANK	Supply and installed by contractor	ABECO or other approved	1	

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CLIENT DEPARTMENT SIGNATURES FACILITY STAMP FACILITY MANAGER INFRASTRUCTURE MANAGER

NODATEDESCRIPTIONDRN22022/03/08REVISED TO ARCHITECTS PLANJMN

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GENERAL MANAGER

Approved as coordination services by Principal Agent

Date:





Mechanical Engineers
Dihlase Consulting Engineers 4 Rockdale Avenue Westville Tel: (031) 266-7861

Fax: 0867605088 Email: dbn@dihlase.co.za

FIRE RETICULATION

PROJECT NAME:

KGOSI SHOPE SECONDARY SCHOOL


OVERALL FIRE PLAN


REF NO: D3888 PAPER SIZE DESIGNED BY: Z VORAGEE SCALE: DRAWN BY: JM NUGENT

D3888-FW-A1-01

CHECKED BY:

R ISMAIL

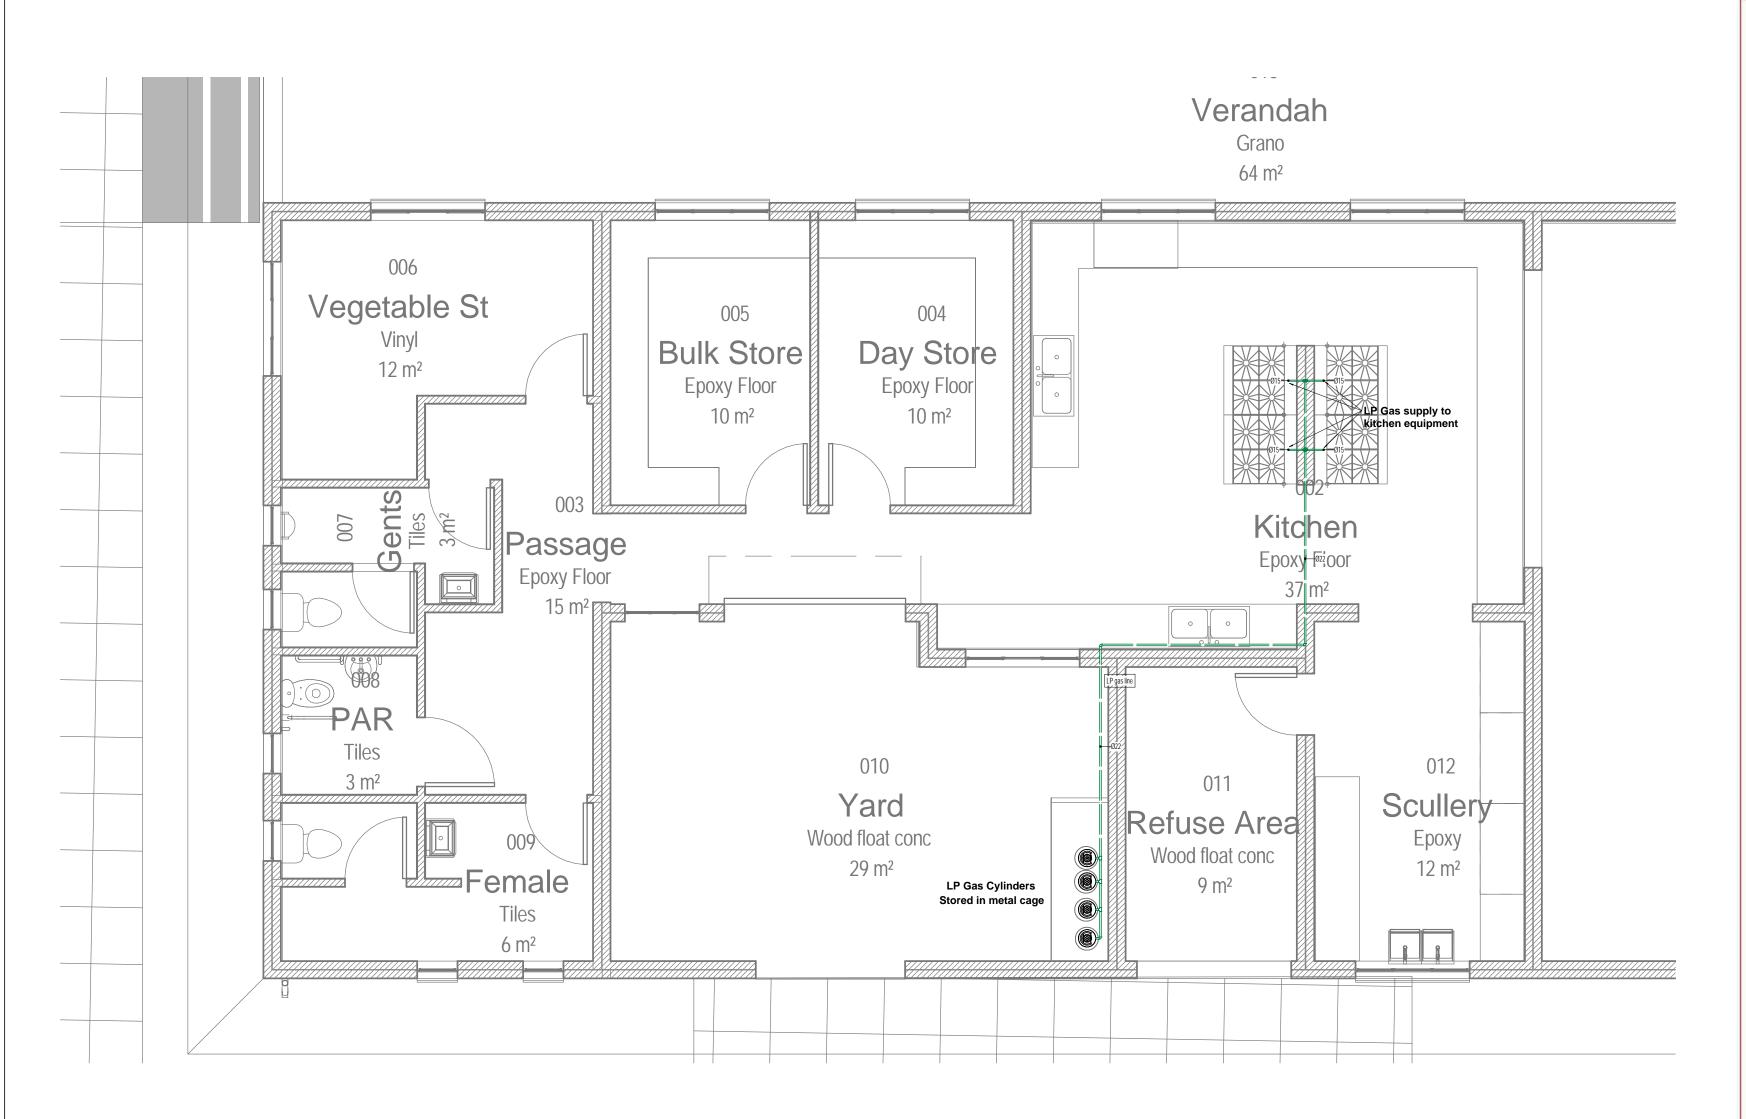

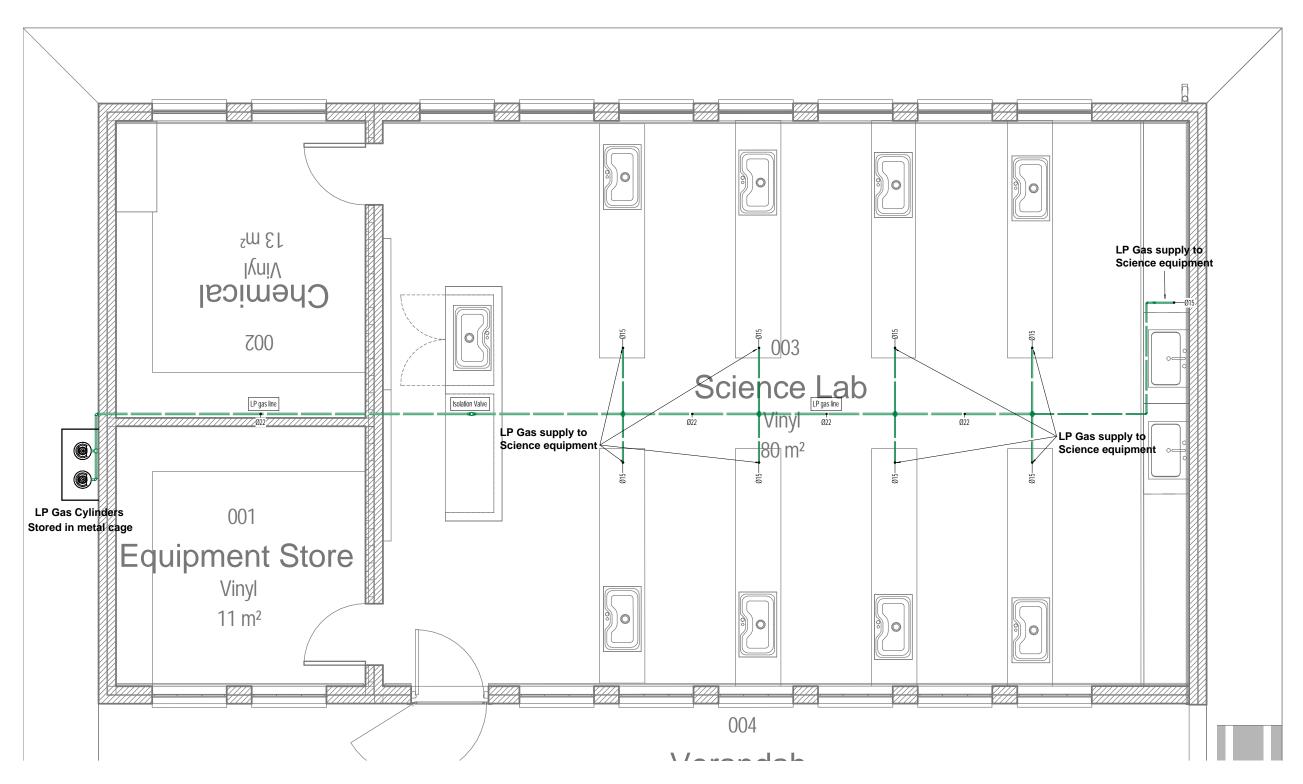

GENERAL REQUIRMENTS FOR LPG INSTALLATIONS

GENERAL NOTES

- a) The installation must be installed in compliance with SANS 100400,10087:1.
- b) One 9kg chemical Powder BC type fire extinguisher must be provided per installation.
- c) SABS approved symbolic:
 - 1."No Smoking"
 - 2."No open fires"
 - 3."No unauthorised persons"
 - 4."No littering at cage"

signs must be provided.

- d) Gas cage must be provided with locks for protection.
- e) No cylinders are allowed to be store outside an approved LPG cage.
- f) LPG signs to be displayed on front of the entrance of the property.
- g) Should have adequate ventilation.
- h) A test certificate must be provided by the installer.
- i) All electric cables must be a minimum of 150mm from any gas pipes, except electric cables in appliances.
- j) Any plugs 200mm away from any gas pipes.
- k) No electrical plug or box may be below any hob.
- I) Gas piping shall not be used as an earth for electrical circuits.
- m) All buried steel pipes must be corrosion protected in an approved manner.
- n) Schedule 40 steel pipes and wrought steel fittings comply with SANS 62-1 to be used.
- o) All underground pipes must be placed a minimum of 50mm below the top of the
- p) Pipes that are to be embedded in concrete must be tested before the completion of
- q) Pipe lines to be tested prior to completions of installations.
- r) However, kitchens must be adequately ventilated by the use of at least one airbrick in an external wall.
- s) A test certificate must be provided before any product is supplied.
- t) Gas supply line must be tamper proof.
- u) The user must ensure that appliances, components of a system be inspected at regular intervals not exceeding 5 years.
- v) All hoses used on outdoor installations must be replaced after 5 years.
- 2. THE LOCAL FIRE DEPARTMENT MUST BE INFORMED AT LEAST TWO (2) WORKIMG DAYS IN ANDVANCE BEFORE WORK ON THE INSTALLATION.

3. GENERAL

Application for a certificate of registrations must be applied for at the fire department, on completion of the installation before any product (LPG) is supplied

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CLIENT	DEPARTMENT	SIGNATURES


FACILITY STAMP

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INFRASTRUCTURE MANAGER

GENERAL MANAGER





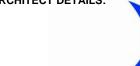

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Dihlase Consulting Engineers Westville Durban Tel: (031) 266-7861 Fax: 0867605088

Email: dbn@dihlase.co.za



MECANICAL BUILDERSWORK

PROJECT NAME:

KGOSI SHOPE SECONDARY SCHOOL

KITCHEN AND SCIENCE LP GAS PLAN

DATE: 2022/03/08 DESIGNED BY: Z VORAGEE PAPER SIZE: SCALE: DRAWN BY: JM NUGENT 1:50 CHECKED BY:

D3888-FW-A1-02

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GENERAL MANAGER

Stamped by Plans Approval Commitee

Date: Approved as coordination services by Principal Agent

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Mechanical Engineers
Dihlase Consulting Engineers
4 Rockdale Avenue Tel: (031) 266-7861 Fax: 0867605088 Email: dbn@dihlase.co.za

MECHANICAL

PROJECT NAME: KGOSI SHOPE SECONDARY SCHOOL

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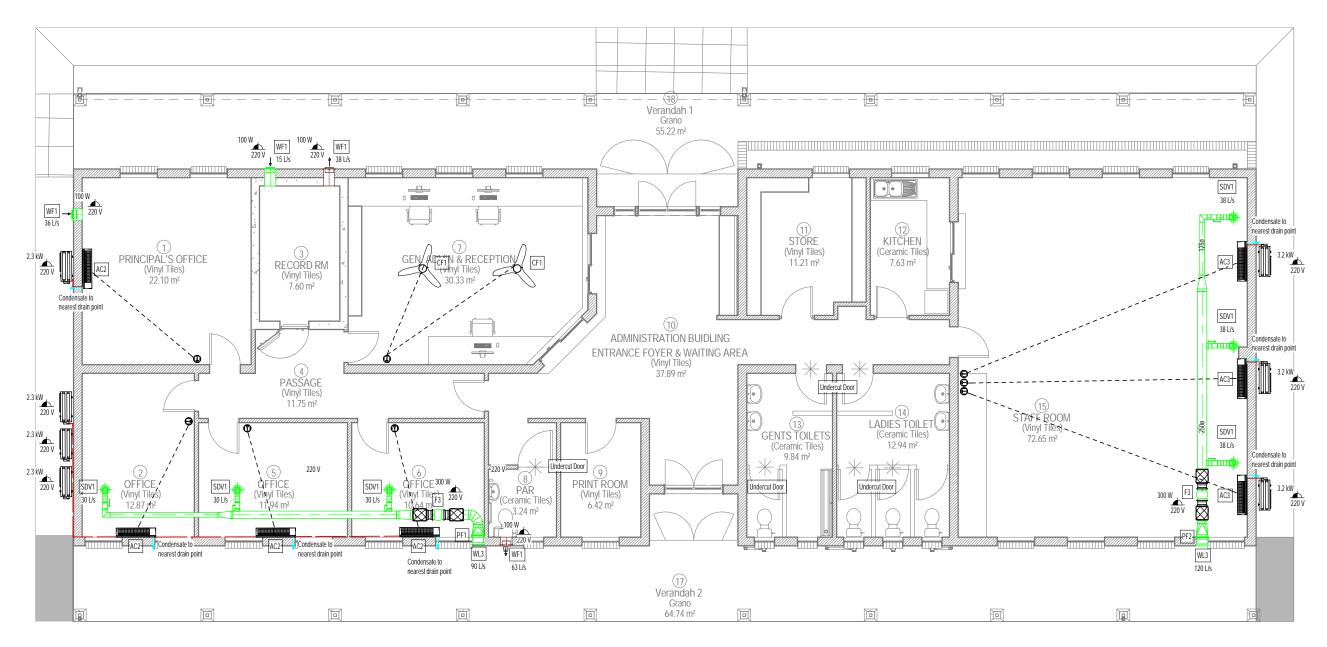
FOR TENDER PURPOSES

FOR CONSTRUCTION

OVERALL HVAC PLAN **REF NO**: D3888

PAPER SIZE: DESIGNED BY: Z VORAGEE SCALE: DRAWN BY: JM NUGENT CHECKED BY: R ISMAIL


D3888-ML-A1-00 Stamped by Plans Approval Commitee




01-ADMIN BLOCK (HVAC)

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		A	ADMIN BLOCK Equipment Schedule			
Tag	Name	Model	Discription	Manufacturer	Size	Qty
SDV1	Disc Valve	Z-LVS 125	Supply and installed by contractor	TROX or other approved	Ø125	6
WF1	Wall Fan	VARIO-150/6/ARI LLS	Supply and installed by contractor	DONKIN or other approved	Ø150	4
F3	Inline Fan	250 VO	Supply and installed by contractor	DONKIN or other approved	Ø250	2
AC2	Midwall	Y5HUZHO18BAM-AFY	Supply and installed by contractor	YORK or other approved		5
AC3	Midwall	Y5HUZHO24BAM-AFY	Supply and installed by contractor	YORK or other approved		3
WL3	Louvre	AWG	Supply and installed by contractor	TROX or other approved	300 x 300	2
CF1	Ceiling Fan	LCF 56	Supply and installed by contractor	LUFT or other approved		2

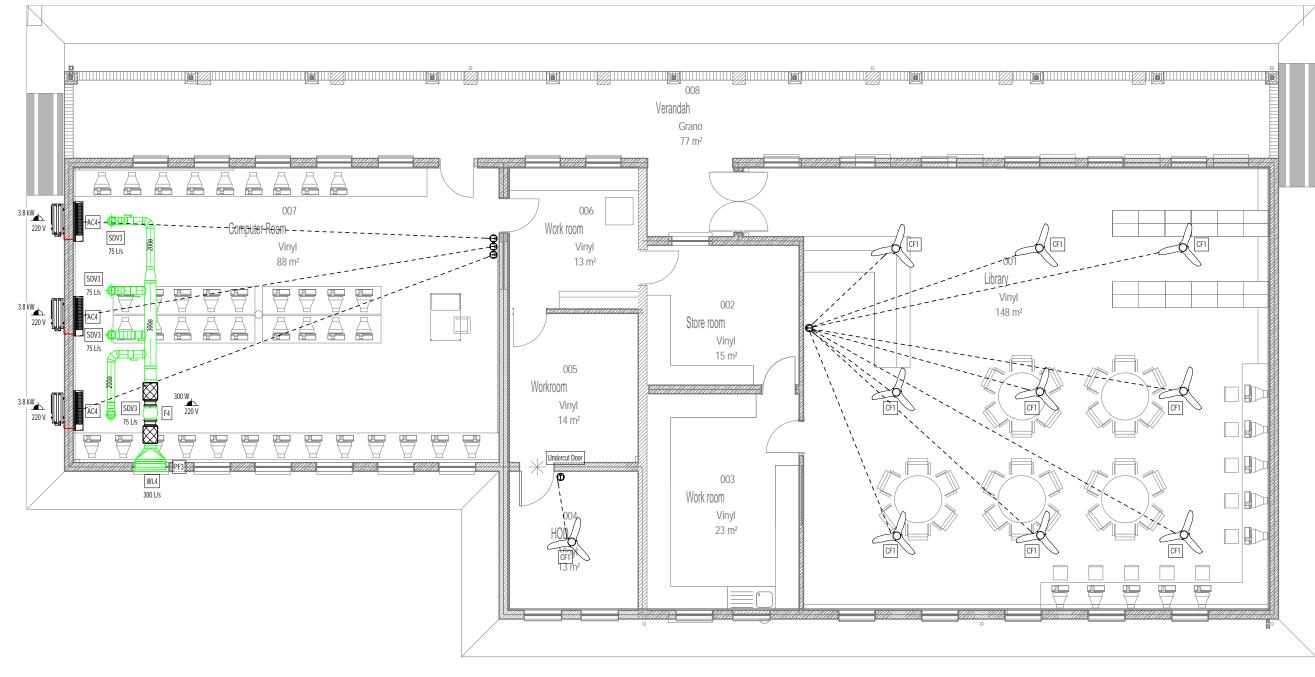

01-COMP & LIBRARY (HVAC)

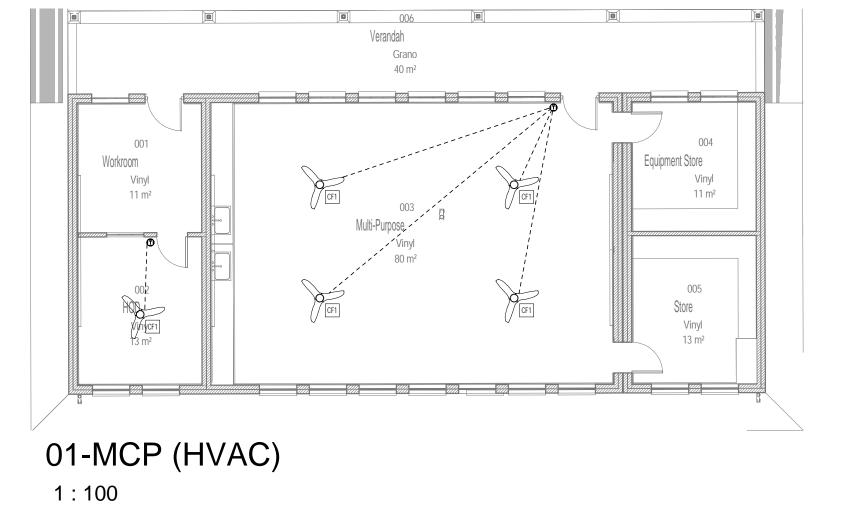

			MCP Equipment Schedule			
Tag	Name	Model	Discription	Manufacturer	Size	Qty
CF1	Ceiling Fan	LCF 56	Supply and installed by contractor	LUFT or other approved		5

HVAC NOTES:

- All flexible ducting shall be of the insulated fire rated type
- Flexible ducting shall not exceed 1500mm in length All filters shall be of the washable permanent type
- All duct sizes indicated are internal free air space
- dimensions
 All external ducting shall be 50mm externally insulated cladded and weatherproofed
- All ducting shall have Mez flanges All condensate drain piping to be sized according to
- manufacturers' specification
- All condensate drain piping shall be copper piping
 All condensate drain piping shall fall to drain point at an
- even fall of no less than 1%
 10. All condensate drain piping on the facade shall be as per
- detail shown 11. Thermostat Controller wiring shall be mounted in Ø20mm uPVC Conduit System - Built/Chased into Walls.
- 12. All air conditioning units on ceiling and diffusers to be
- centered with ceiling tiles 13. All air conditioning ducting to be externally insulated 14. Extract grille to be installed above horizontal bedhead
- trunking 15. Bulkhead around exposed extract ducting to be to
- architects detail
- 16. Whilst the drawings may refer to specific items, brands or equipment. All equipment offered to be as specified or equal or approved

COMP & LIBRARY Equipment Schedule						
Tag	Name	Model	Discription	Manufacturer	Size	Qty
SDV3	Disc Valve	Z-LVS 200	Supply and installed by contractor	TROX or other approved	Ø200	4
CF1	Ceiling Fan	LCF 56	Supply and installed by contractor	LUFT or other approved		10
F4	Inline Fan	315 VO	Supply and installed by contractor	DONKIN or other approved	Ø315	1
AC4	Midwall	Y5HUZHO30BAM-AFY	Supply and installed by contractor	YORK or other approved		3
WL4	Louvre	AWG	Supply and installed by contractor	TROX or other approved	800 x 300	1


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FACILITY MANAGER

INFRASTRUCTURE MANAGER

GENERAL

MANAGER

CLIENT NAME:

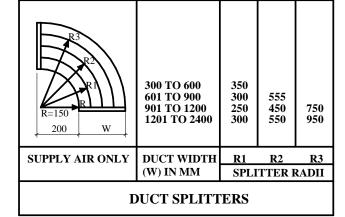

ARCHITECT DETAILS:



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CONSULTANTS DETAILS: Mechanical Engineers Dihlase Consulting Engineers 4 Rockdale Avenue Westville Durban

Tel: (031) 266-7861 Fax: 0867605088 Email: dbn@dihlase.co.za

MECHANICAL

PROJECT NAME:

KGOSI SHOPE SECONDARY SCHOOL

SHEET TITLE:

HVAC PLANS part 1


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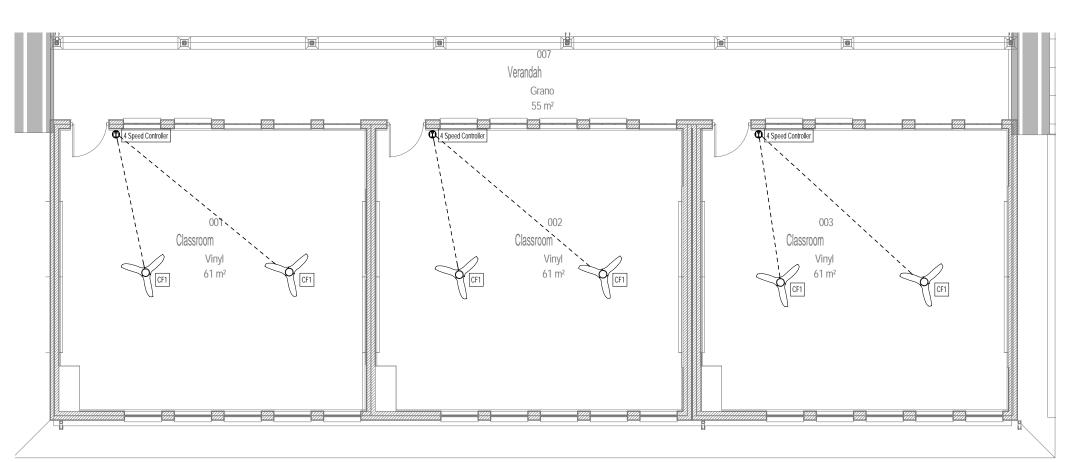
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01-CL2, ABU & HOD (HVAC)

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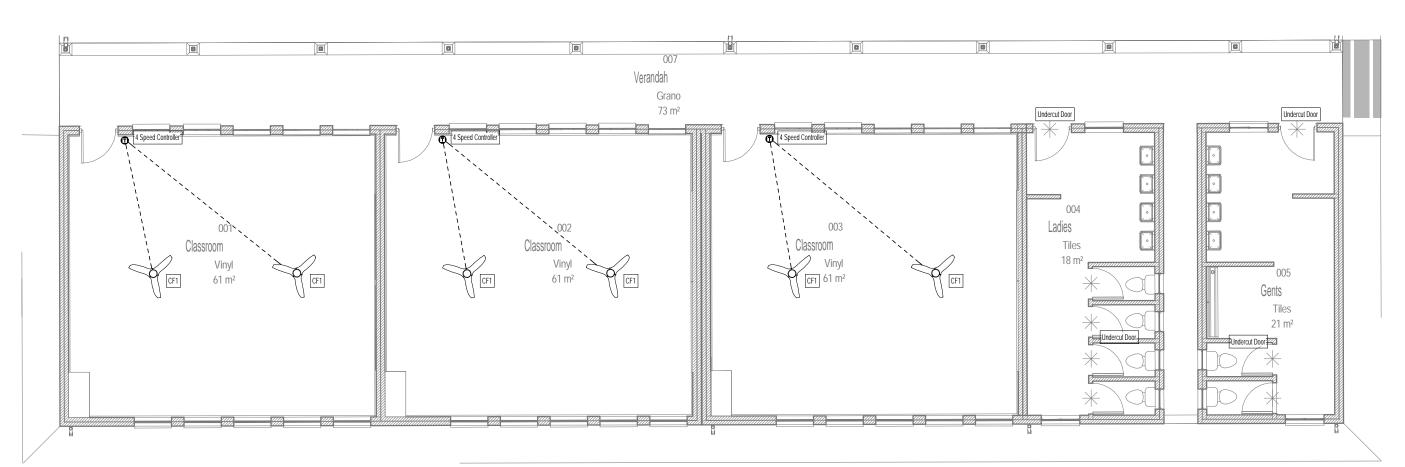
	CL2, ABU & HOD Equipment Schedule					
Tag	Tag Name Model		Discription	Manufacturer	Size	Qty
CF1	Ceiling Fan	LCF 56	Supply and installed by contractor	LUFT or other approved		4
WF1	Wall Fan	VARIO-150/6/ARI LLS	Supply and installed by contractor	DONKIN or other approved	Ø150	1



01-CL3 (HVAC)

1:100

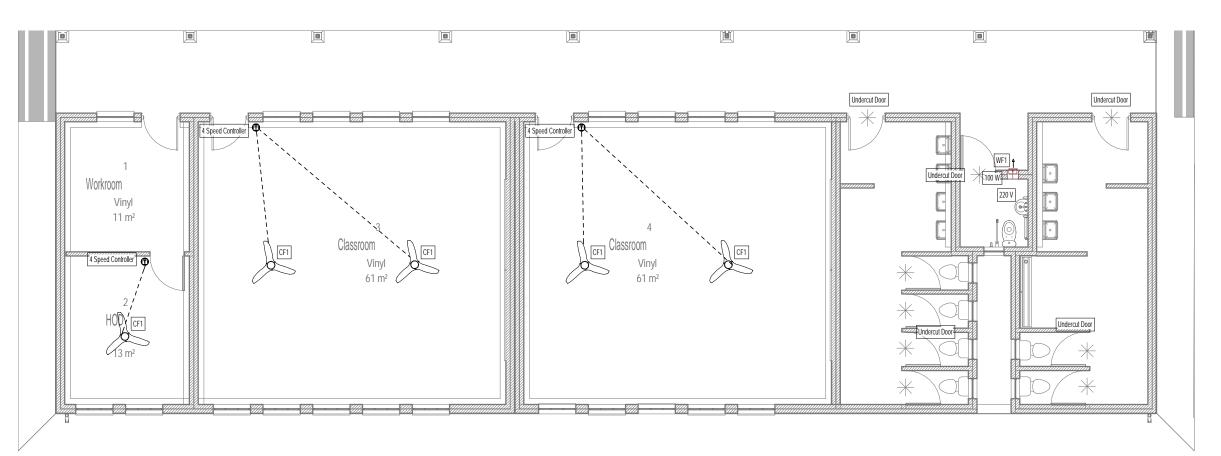CL3 Equipment Schedule					
Tag	Name	Model	Discription	Manufacturer	Qty
CF1	Ceiling Fan	LCF 56	Supply and installed by contractor	LUFT or other approved	6



01-CL3 ABU (HVAC)

1:100

CL3 ABU Equipment Schedule						
Tag	Name	Model	Discription	Manufacturer	Size	Qty
CF1	Ceiling Fan	LCF 56	Supply and installed by contractor	LUFT or other approved		6

HVAC NOTES:


- All flexible ducting shall be of the insulated fire rated type
- Flexible ducting shall not exceed 1500mm in length All filters shall be of the washable permanent type
- All duct sizes indicated are internal free air space
- All external ducting shall be 50mm externally insulated cladded and weatherproofed
- All ducting shall have Mez flanges
- All condensate drain piping to be sized according to manufacturers' specification
- All condensate drain piping shall be copper piping All condensate drain piping shall fall to drain point at an
- even fall of no less than 1% 10. All condensate drain piping on the facade shall be as per
- detail shown 11. Thermostat Controller wiring shall be mounted in Ø20mm
- uPVC Conduit System Built/Chased into Walls.
- 12. All air conditioning units on ceiling and diffusers to be
- centered with ceiling tiles
- trunking
- architects detail
 16. Whilst the drawings may refer to specific items, brands or approved

- 13. All air conditioning ducting to be externally insulated 14. Extract grille to be installed above horizontal bedhead
- 15. Bulkhead around exposed extract ducting to be to
- equipment. All equipment offered to be as specified or equal or

PRELIMINARY		
FOR INFORMATION ONLY		-
FOR APPROVAL	/	
FOR TENDER PURPOSES		
FOR CONSTRUCTION		

NOTES:

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- DIMENSIONS TO BE VERIFIED ON SITE PRIOR TO COMMENCEMENT OF WORKS. ANY DISCREPANCIES TO BE BROUGHT TO THE ENGINEERS ATTENTION IMMEDIATELY THIS DRAWING IS TO BE READ IN CONJUNCTION WITH ALL OTHER DRAWINGS, SCHEDULES AND SPECIFICATIONS
- RELATED TO THIS PROJECT. 4. ALL BUILDING WORK AND MATERIALS ARE TO COMPLY WITH LOCAL AUTHORITY'S REQUIREMENTS AND ARE TO BE IN ACCORDANCE WITH SANS 10400 NATIONAL BUILDING REGULATIONS

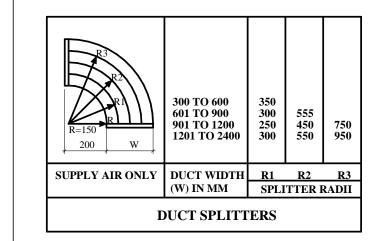

NO	DATE	DESCRIPTION	DRN BY
2	2022/03/08	REVISED TO ARCHITECTS PLAN	JMN

CLIENT DEPARTMENT SIGNATURES FACILITY STAMP

FACILITY MANAGER

INFRASTRUCTURE MANAGER

GENERAL MANAGER

CLIENT NAME:



ARCHITECT DETAILS:



UKUZA CONSULTING (PTY) LTD

CONSULTANTS DETAILS: Mechanical Engineers Dihlase Consulting Engineers

4 Rockdale Avenue Westville Durban Tel: (031) 266-7861 Fax: 0867605088

Email: dbn@dihlase.co.za



MECHANICAL

PROJECT NAME:

KGOSI SHOPE SECONDARY SCHOOL

SHEET TITLE:

HVAC PLANS part 2

REF NO: D3888 DATE: 2022/03/08 PAPER SIZE: DESIGNED BY: Z VORAGEE SCALE: DRAWN BY: JM NUGENT As indicated CHECKED BY: R ISMAIL

DRAWING NUMBER:

D3888-ML-A1-02


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HVAC NOTES:

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approved


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01-SCIENCE LAB (HVAC)

1:100


SCIENCE LAB Equipment Schedule					
Tag	Name	Model	Discription	Manufacturer	Qty
CF1	Ceiling Fan	LCF 56	Supply and installed by contractor	LUFT or other approved	6

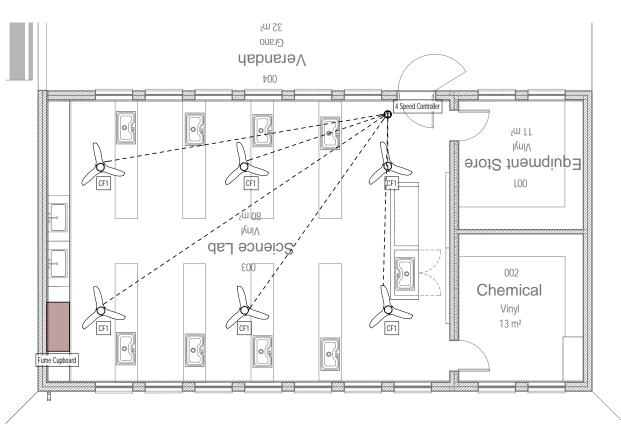

01-KITCHEN & DINNING (HVAC)

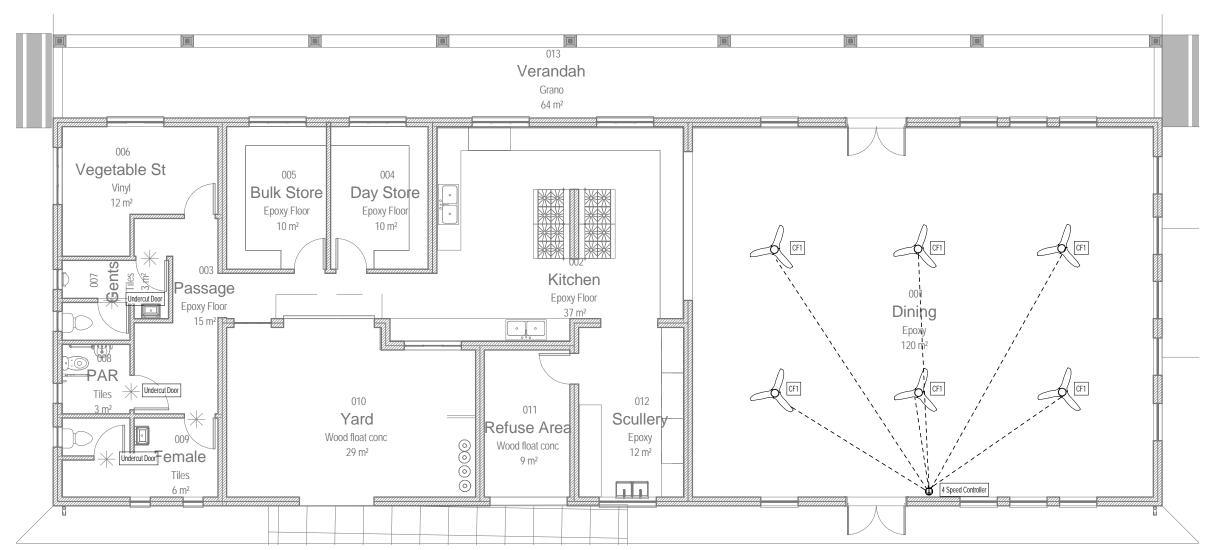
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KITCHEN & DINNING Equipment Schedule						
Tag	Name	Model	Discription	Manufacturer	Qty	
CF1	Ceiling Fan	LCF 56	Supply and installed by contractor	LUFT or other approved	6	

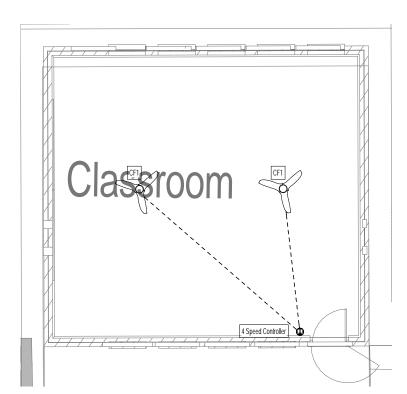


01-EX CL1 (HVAC)

1:100

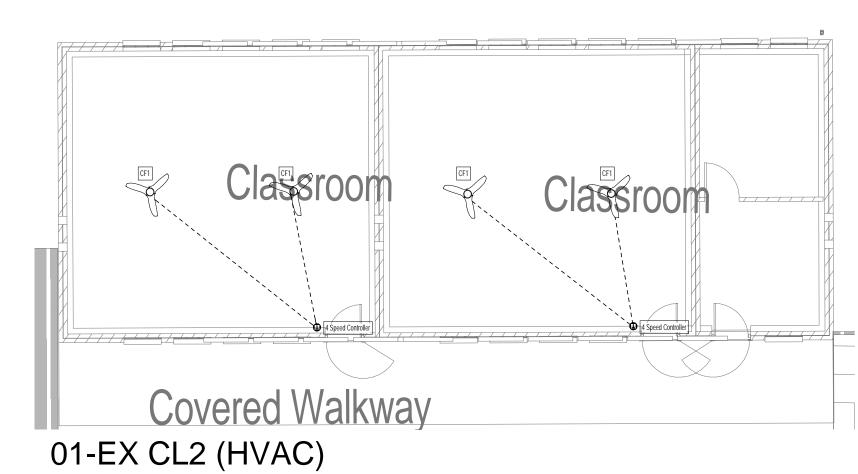

1:100

EX CL1 & CL2 Equipment Schedule					
Tag	Name	Model	Discription	Manufacturer	Qty
CF1	Ceiling Fan	LCF 56	Supply and installed by contractor	LUFT or other approved	6

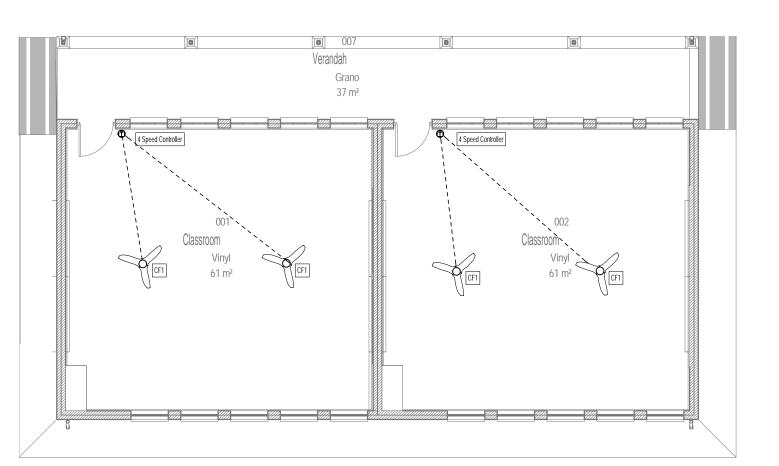

01-CL2 (HVAC)

1:100

CL2 Equipment Schedule					
Tag	Name	Model	Discription	Manufacturer	Qty
CF1	Ceiling Fan	LCF 56	Supply and installed by contractor	LUFT or other approved	4

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FOR APPROVAL	1
FOR TENDER PURPOSES	
FOR CONSTRUCTION	

NOTES:

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- BROUGHT TO THE ENGINEERS ATTENTION IMMEDIATELY THIS DRAWING IS TO BE READ IN CONJUNCTION WITH ALL OTHER DRAWINGS, SCHEDULES AND SPECIFICATIONS
- RELATED TO THIS PROJECT. ALL BUILDING WORK AND MATERIALS ARE TO COMPLY WITH LOCAL AUTHORITY'S REQUIREMENTS AND ARE TO BE IN ACCORDANCE WITH SANS 10400 NATIONAL BUILDING REGULATIONS

)	DATE	DESCRIPTION	DRN BY

CLIENT DEPARTMENT SIGNATURES

FACILITY STAMP

FACILITY MANAGER

INFRASTRUCTURE

MANAGER

GENERAL MANAGER

CLIENT NAME:



Education and Sport Development
Department of Education and Sport Development
Departement van Onderwys en Sportontwikkeling Lefapha la Thuto le Tihabololo ya Metshameko NORTH WEST PROVINCE



UKUZA CONSULTING (PTY) LTD

CONSULTANTS DETAILS: Mechanical Engineers Dihlase Consulting Engineers 4 Rockdale Avenue

Westville Durban Tel: (031) 266-7861 Fax: 0867605088 Email: dbn@dihlase.co.za

MECHANICAL

PROJECT NAME:

KGOSI SHOPE SECONDARY SCHOOL

SHEET TITLE:

HVAC PLANS part 3

DATE: 2022/03/08	REF NO: D3888
PAPER SIZE: A1	DESIGNED BY: Z VORAGEE
SCALE:	DRAWN BY: JM NUGENT
As indicated	CHECKED BY: R ISMAIL

D3888-ML-A1-03

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3. THIS DRAWING IS TO BE READ IN CONJUNCTION WITH ALL OTHER DRAWINGS, SCHEDULES AND SPECIFICATIONS
RELATED TO THIS PROJECT. 4. ALL BUILDING WORK AND MATERIALS ARE TO COMPLY WITH LOCAL AUTHORITY'S REQUIREMENTS AND ARE TO BE IN

1. ALL BUILDING WORK AND MATERIALS ARE TO COMPLY WITH LOCAL AUTHORITY'S REQUIREMENTS AND ARE TO BE IN

ACCORDANCE WITH SANS 10400 NATIONAL BUILDING REGULATIONS **LEGEND**

Ø50 mm - uPVC Class 16 Waste Pipe Ø110 mm - uPVC Class 16 Waste Pipe Ø110 mm - uPVC Class 34 Waste Pipe Ø50 mm - uPVC Class 16 Rain Pipe Ø75 mm - uPVC Class 16 Rain Pipe

Ø110 mm - uPVC Class 16 Rain Pipe

NODATEDESCRIPTIONDRN BY22022/03/08REVISED TO ARCHITECTS PLANJMN

FACILITY STAMP

CLIENT DEPARTMENT SIGNATURES

FACILITY MANAGER

INFRASTRUCTURE

GENERAL MANAGER

MANAGER

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Approved as coordination services by Principal Agent





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MECHANICAL


PROJECT NAME: KGOSI SHOPE SECONDARY SCHOOL

OVERALL DRAINAGE PLAN **REF NO**: D3888

PAPER SIZE: DESIGNED BY: Z VORAGEE DRAWN BY: JM NUGENT SCALE: CHECKED BY: R ISMAIL


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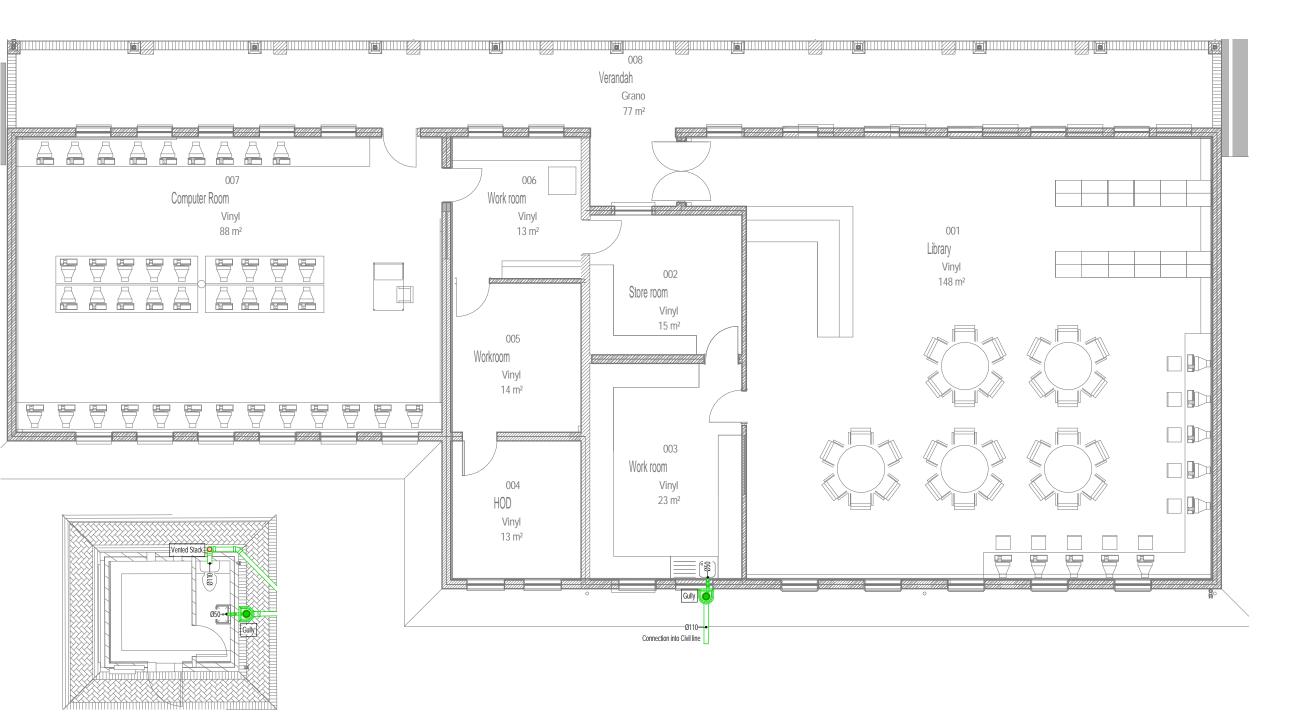
01-ADMIN BLOCK (SW)

1:100

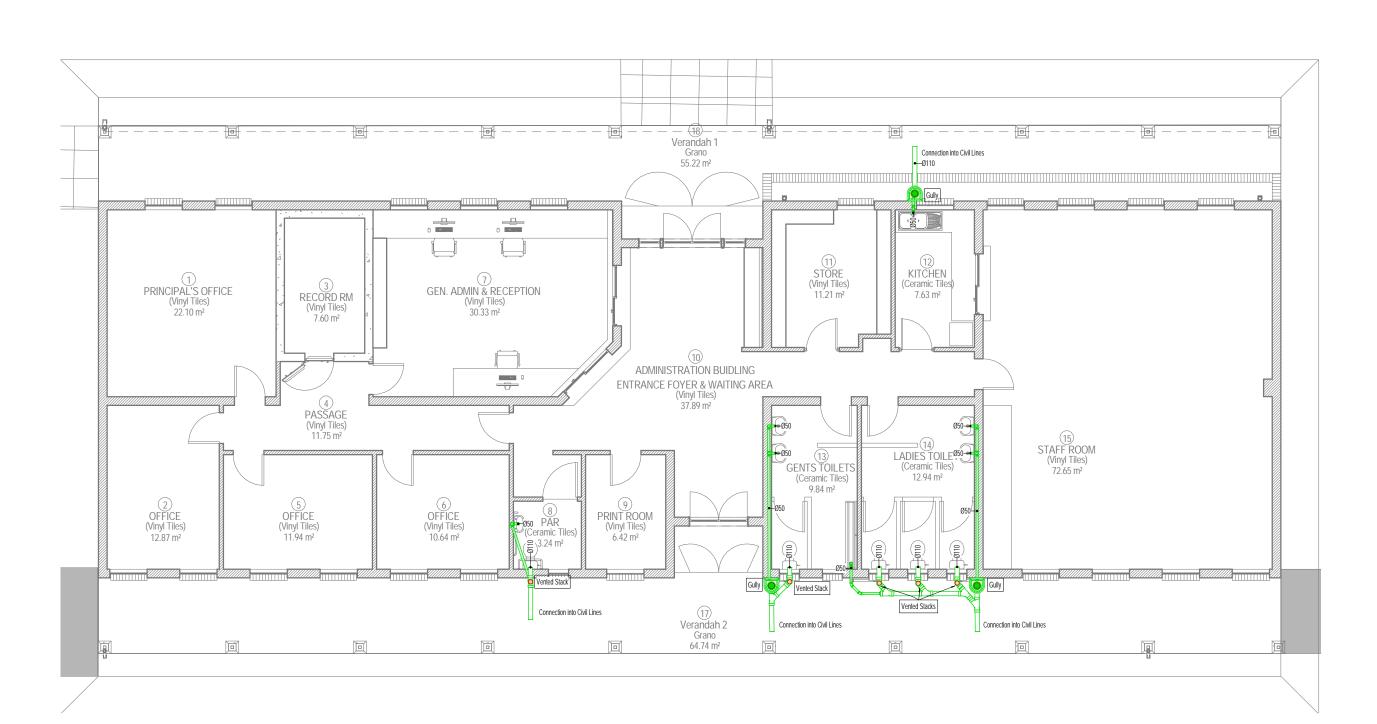

01-KITCHEN & DINNING (SW)

1:100

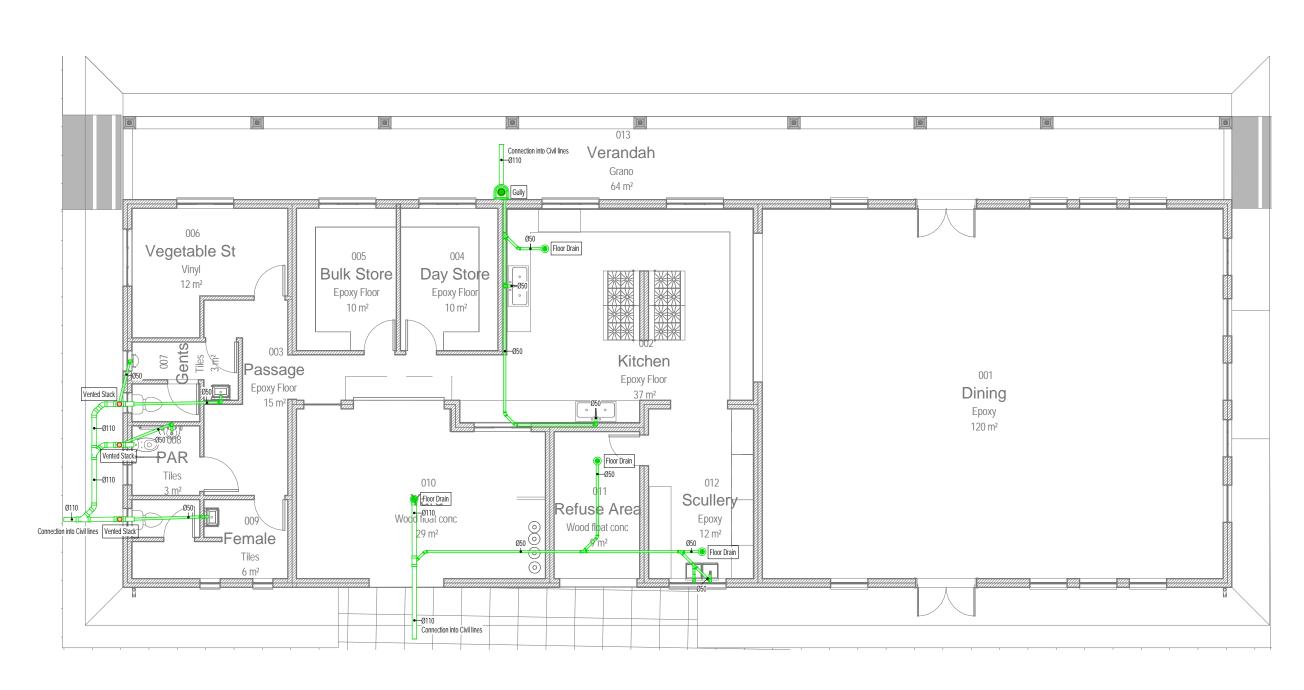

1:100

01-GUARD HOUSE (SW)

1:100

01-COMP & LIBRARY (SW)

 $13~\mathrm{M}_\mathrm{S}$ lγniV Chemical Science Lab **■Equipment Store** Verandah Grano

01-SCIENCE LAB (SW)

1:100

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- THIS DRAWING IS TO BE READ IN CONJUNCTION WITH ALL OTHER DRAWINGS, SCHEDULES AND SPECIFICATIONS RELATED TO THIS
- ALL BUILDING WORK AND MATERIALS ARE TO COMPLY WITH LOCAL AUTHORITY'S REQUIREMENTS AND ARE TO BE IN ACCORDANCE WITH
- SANS 10400 NATIONAL BUILDING REGULATIONS. - ALL REQUIREMENTS LAID DOWN BY THE LOCAL AUTHORITY, SANS 10252 AND SANS 10254 CODES OF PRACTICE MUST BE STRICTLY
- PIPE RUNS ARE DIAGRAMMATICALLY INDICATED ON THE DRAWINGS. THEIR EXACT POSITION SHOULD BE ESTABLISHED ON SITE.
- MAJOR RE-POSITIONING OF PIPE-WORK MAY AFFECT THE CRITERIA ON WHICH THE CALCULATIONS ARE BASED AND SHOULD THUS BE PRE-CHECKED BY THE ENGINEER BEFORE PROCEEDING WITH THE INSTALLATION.
- FINAL SANITARY FIXTURE POSITIONS AND SETTING OUT TO BE COORDINATED WITH THE ARCHITECTS PLAN. APPROVALS FOR SETTING OUT NEED TO BE OBTAINED FROM THE ARCHITECT.
- ALL PIPE RUNS SHOULD BE FLUSHED, FASTENED AND PRESSURE TESTED, PRIOR TO THE APPLICATION OF ANY TERMINAL FITTINGS.
- ANY PIPE CAST INTO SLABS MUST BE SLEEVED USING TUBE OF SUITABLE SIZE.
- ALL UNDERGROUND PIPE WORK TO BE HDPE, ALL EXPOSED PIPEWORK TO BE HDPE
- DESIGNS BASED ON FITTINGS SPECIFIED. ANY CHANGES IN SPECIFICATION OF FITTINGS WILL DEEM THIS INSTALLATION INVALID. IF SPECIFICATION OF FITTING IS CHANGED AT ANY TIME, THE DESIGNER SHOULD BE CONSULTED REGARDING THE CHANGES.
- ALL WASH HAND BASINS TO HAVE BOTTLE TRAPS
- ALL SINKS TO HAVE P-TRAPS

ADHERED TO.

- ALL SHOWERS TO BE COMPLETE WITH TRAPS - ALL FLOOR DRAINS TO BE COMPLETE WITH TRAPS
- ALL FITTINGS TO TIE INTO GULLY, VENTED STACK OR VENT HORNS BEFORE TYING INTO EXTERNAL RETICULATION VIA MANHOLES
- ALL STACKS TO BE COMPLETE WITH 2 WAY VENT VALVES - ALL FITTINGS TO BE VENTED UNLESS OTHERWISE STATED.

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FOR APPROVAL	~
FOR TENDER PURPOSES	
FOR CONSTRUCTION	

2	2022/03/08	REVISED TO ARCHITECTS PLAN	JMN

DESCRIPTION

CLIENT DEPARTMENT SIGNATURES

FACILITY STAMP

NOTES:

FOR GENERAL NOTES REFER TO DRAWING

RELATED TO THIS PROJECT.

REGULATIONS

DIMENSIONS TO BE VERIFIED ON SITE PRIOR TO COMMENCEMENT OF WORKS. ANY DISCREPANCIES TO BE BROUGHT TO THE ENGINEERS ATTENTION IMMEDIATELY THIS DRAWING IS TO BE READ IN CONJUNCTION WITH ALL OTHER DRAWINGS, SCHEDULES AND SPECIFICATIONS

I. ALL BUILDING WORK AND MATERIALS ARE TO COMPLY WITH LOCAL AUTHORITY'S REQUIREMENTS AND ARE TO BE IN ACCORDANCE WITH SANS 10400 NATIONAL BUILDING

FACILITY MANAGER

INFRASTRUCTURE MANAGER

GENERAL MANAGER

CLIENT NAME:





UKUZA CONSULTING (PTY) LTD

CONSULTANTS DETAILS: Mechanical Engineers Dihlase Consulting Engineers 4 Rockdale Avenue Westville Durban

Tel: (031) 266-7861

Fax: 0867605088

Email: dbn@dihlase.co.za

MECHANICAL

PROJECT NAME:

KGOSI SHOPE SECONDARY SCHOOL


SHEET TITLE:

DRAINAGE PLANS

IF .	DATE: 2022/03/08	REF NO: D3888
	PAPER SIZE: A1	DESIGNED BY: Z VORAGEE
	SCALE: As indicated	DRAWN BY: JM NUGENT
		CHECKED BY: R ISMAIL

DRAWING NUMBER: D3888-SW-A1-01

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01-CL 2 ABU (SW)

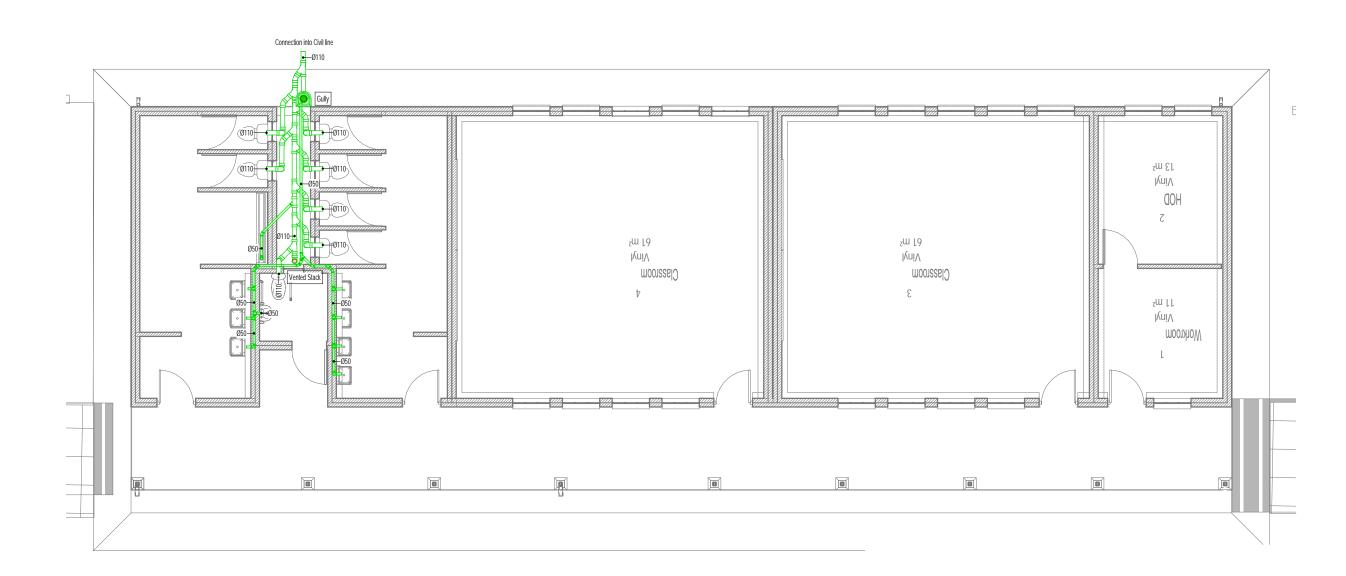1:100

- FOR GENERAL NOTES REFER TO DRAWINGS.

IMMEDIATELY.

SUITABLE SIZE.

PIPEWORK TO BE HDPE

- ALL SINKS TO HAVE P-TRAPS

- DRAWINGS ARE NOT TO BE SCALED. ALL LEVELS AND DIMENSIONS TO BE VERIFIED ON SITE PRIOR TO COMMENCEMENT OF WORKS.

- THIS DRAWING IS TO BE READ IN CONJUNCTION WITH ALL OTHER

- ALL BUILDING WORK AND MATERIALS ARE TO COMPLY WITH LOCAL

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- ALL SHOWERS TO BE COMPLETE WITH TRAPS


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SANS 10400 NATIONAL BUILDING REGULATIONS.

DRAWINGS, SCHEDULES AND SPECIFICATIONS RELATED TO THIS

AUTHORITY'S REQUIREMENTS AND ARE TO BE IN ACCORDANCE WITH

ANY DISCREPANCIES TO BE BROUGHT TO THE ENGINEERS ATTENTION

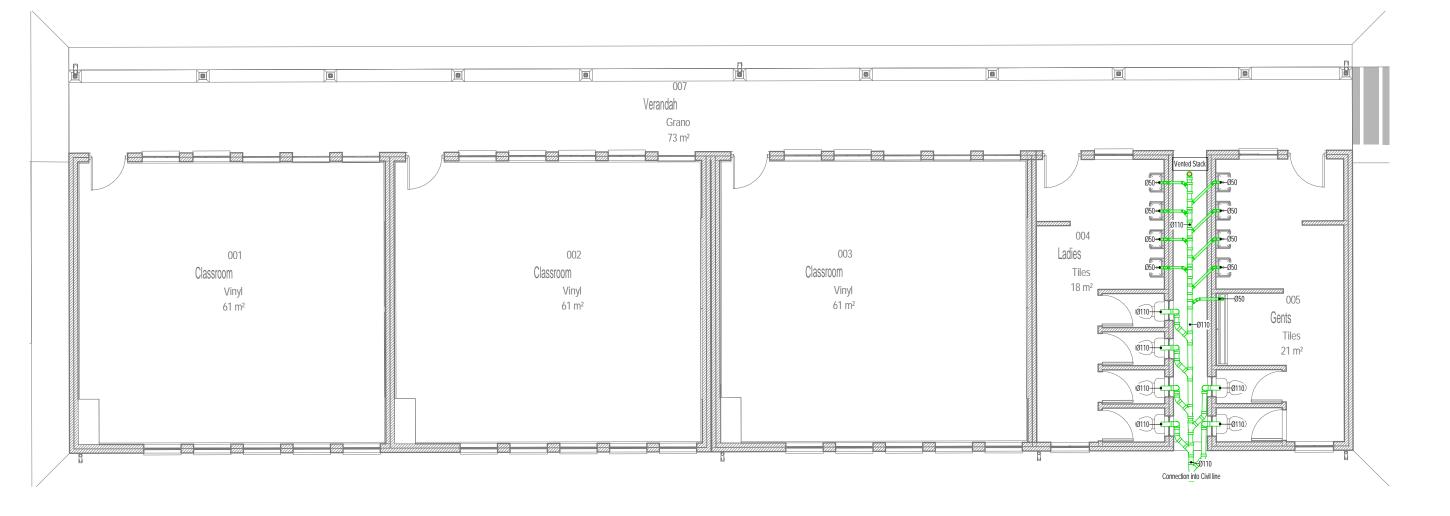

01-CL 3 ABU (SW)

1:100

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FOR CONSTRUCTION

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NO	DATE	DESCRIPTION	DRN BY
2	2022/03/08	REVISED TO ARCHITECTS PLAN	JMN

CLIENT DEPARTMENT SIGNATURES

FACILITY STAMP

FACILITY MANAGER

INFRASTRUCTURE MANAGER

MANAGER

GENERAL

CLIENT NA



Department of Education and Sport Development
Department van Onderwys en Sportontwikkeling
Lefapha la Thuto le Tihabololo ya Metshameko
NORTH WEST PROVINCE



UKUZA CONSULTING (PTY) LTD

CONSULTANTS DETAILS:

Mechanical Engineers

Dihlase Consulting Engineers

4 Rockdale Avenue

Westville

Durban

Tel: (031) 266-7861

Fax: 0867605088

ARCHITECT DETAILS:

DIHLASE

MECHANICAL

PROJECT NAME:

Email: dbn@dihlase.co.za

KGOSI SHOPE SECONDARY SCHOOL

SHEET TITLE:

DRAINAGE PLANS

	DATE: 2022/03/08	REF NO: D3888
	PAPER SIZE: A1	DESIGNED BY: Z VORAGEE
	SCALE: As indicated	DRAWN BY: JM NUGENT
		CHECKED BY: R ISMAIL

DRAWING NUMBER:

D3888-SW-A1-02

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