




Typical 6 Classroom Floor Plan
Scale - 1:100

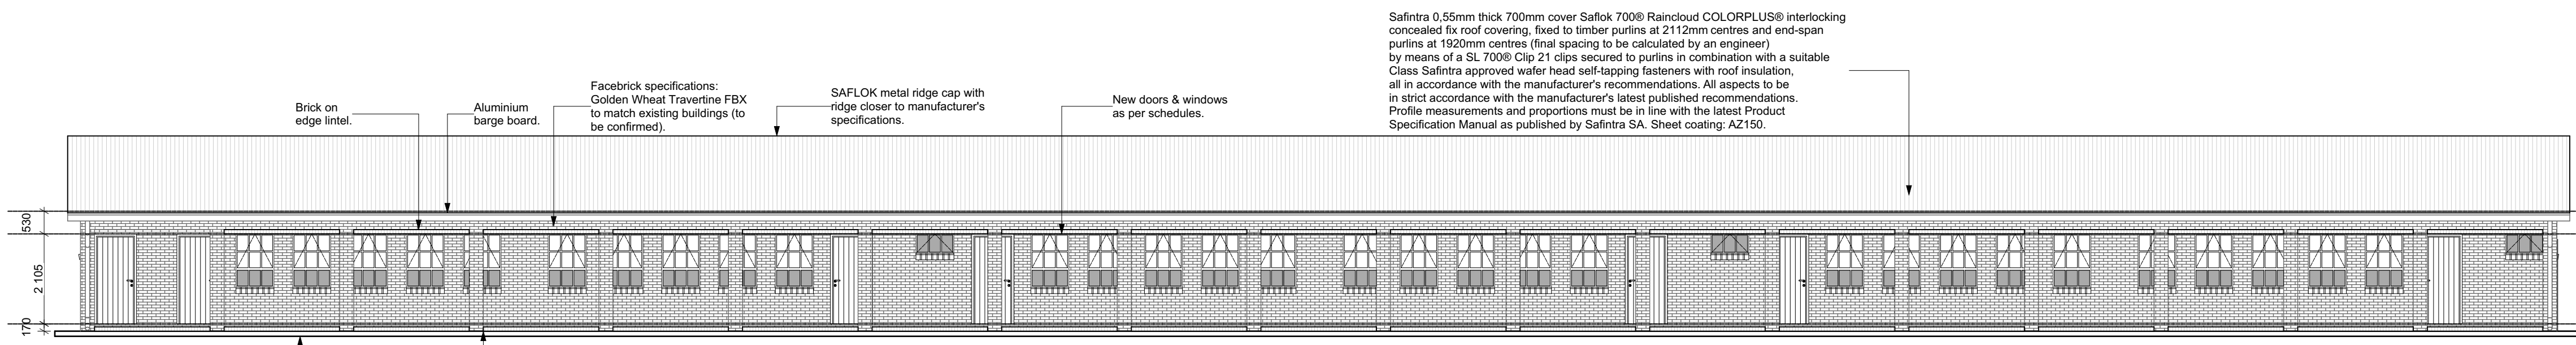


Typical 6 Classroom Front Elevation
Scale - 1:100

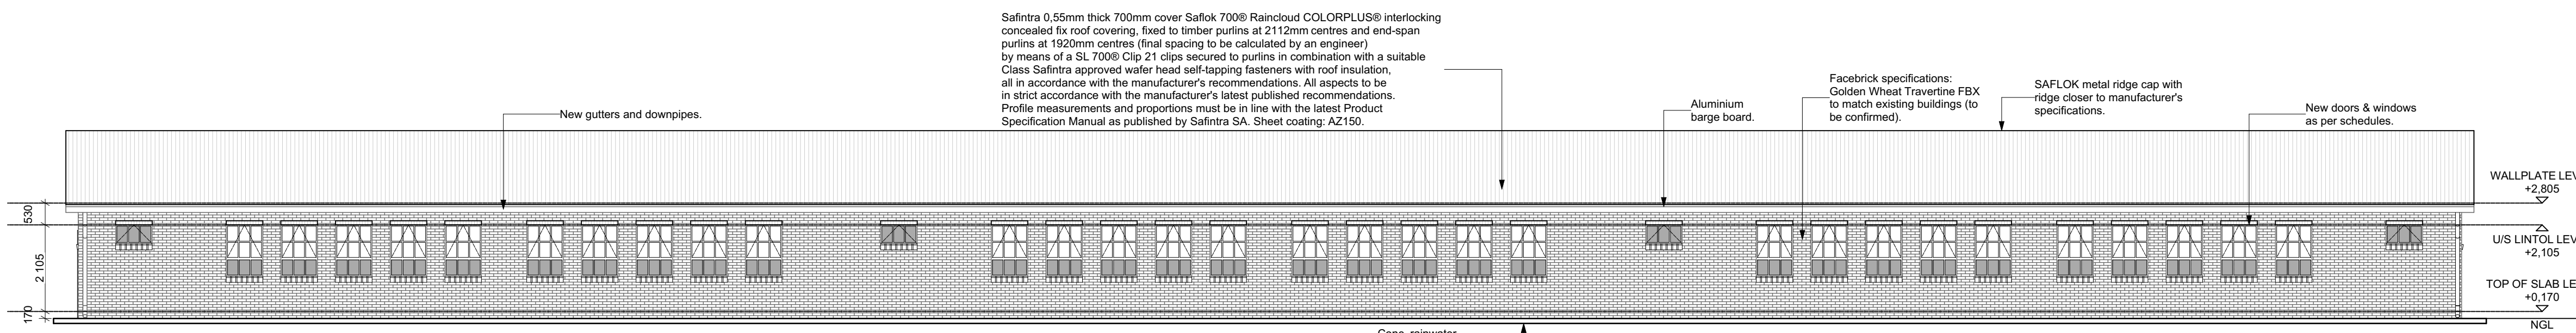


Typical 6 Classroom Rear Elevation
Scale - 1:100

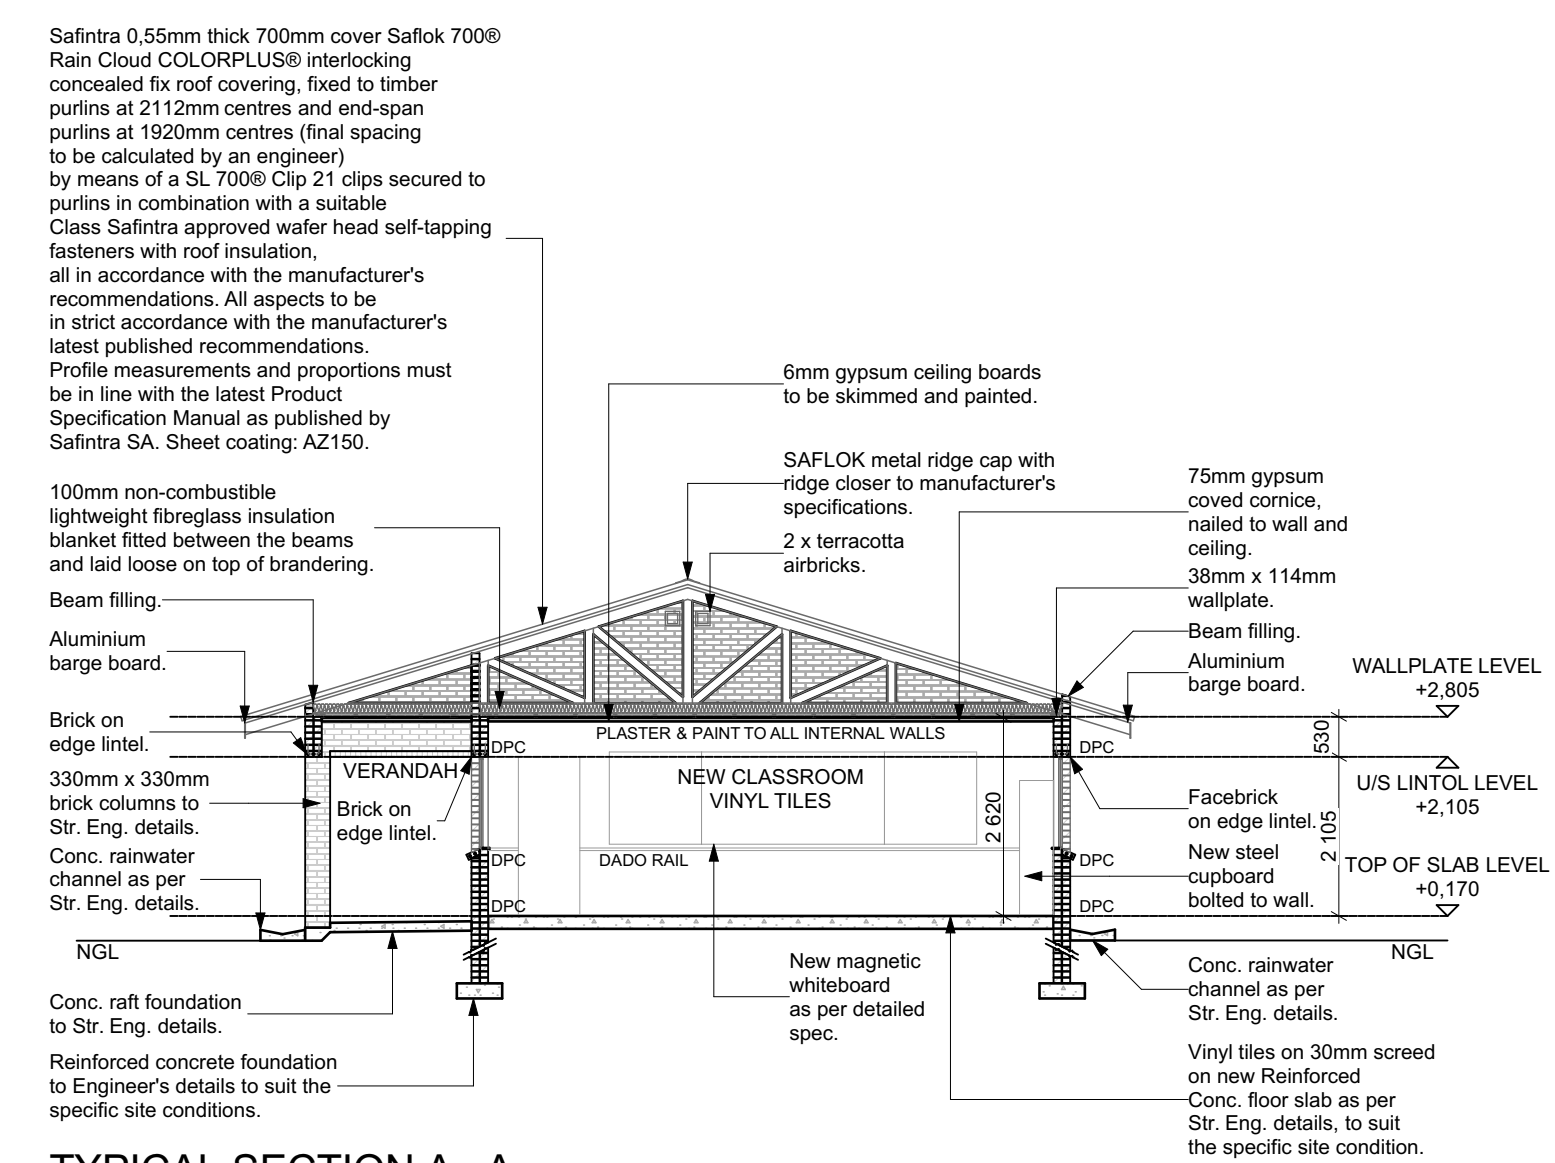


Typical Section A-A
Scale - 1:100

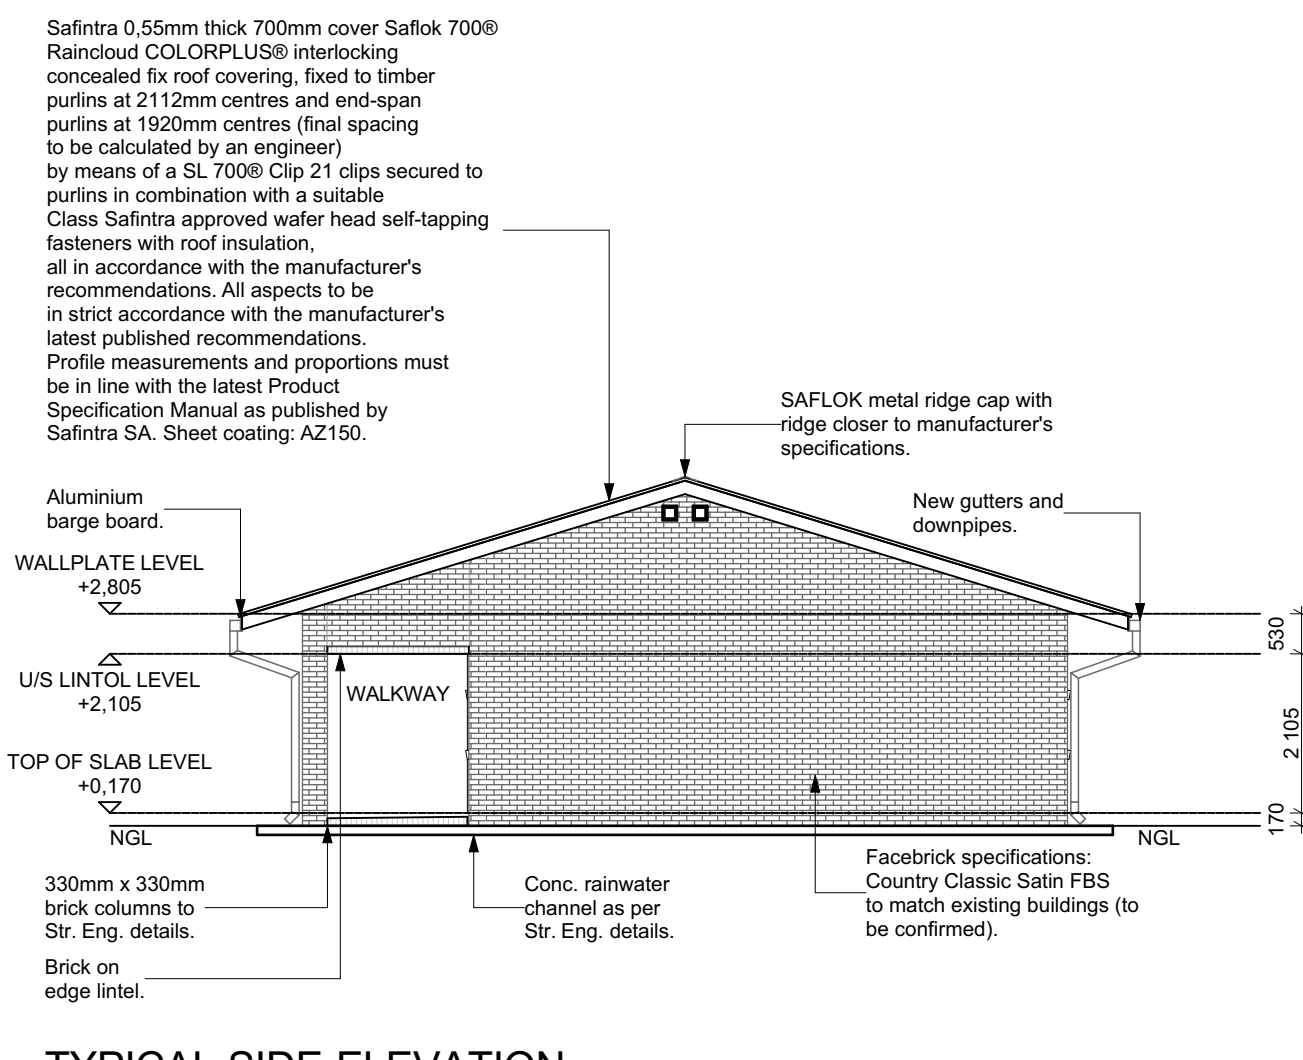

Typical Side Elevation
Scale - 1:100

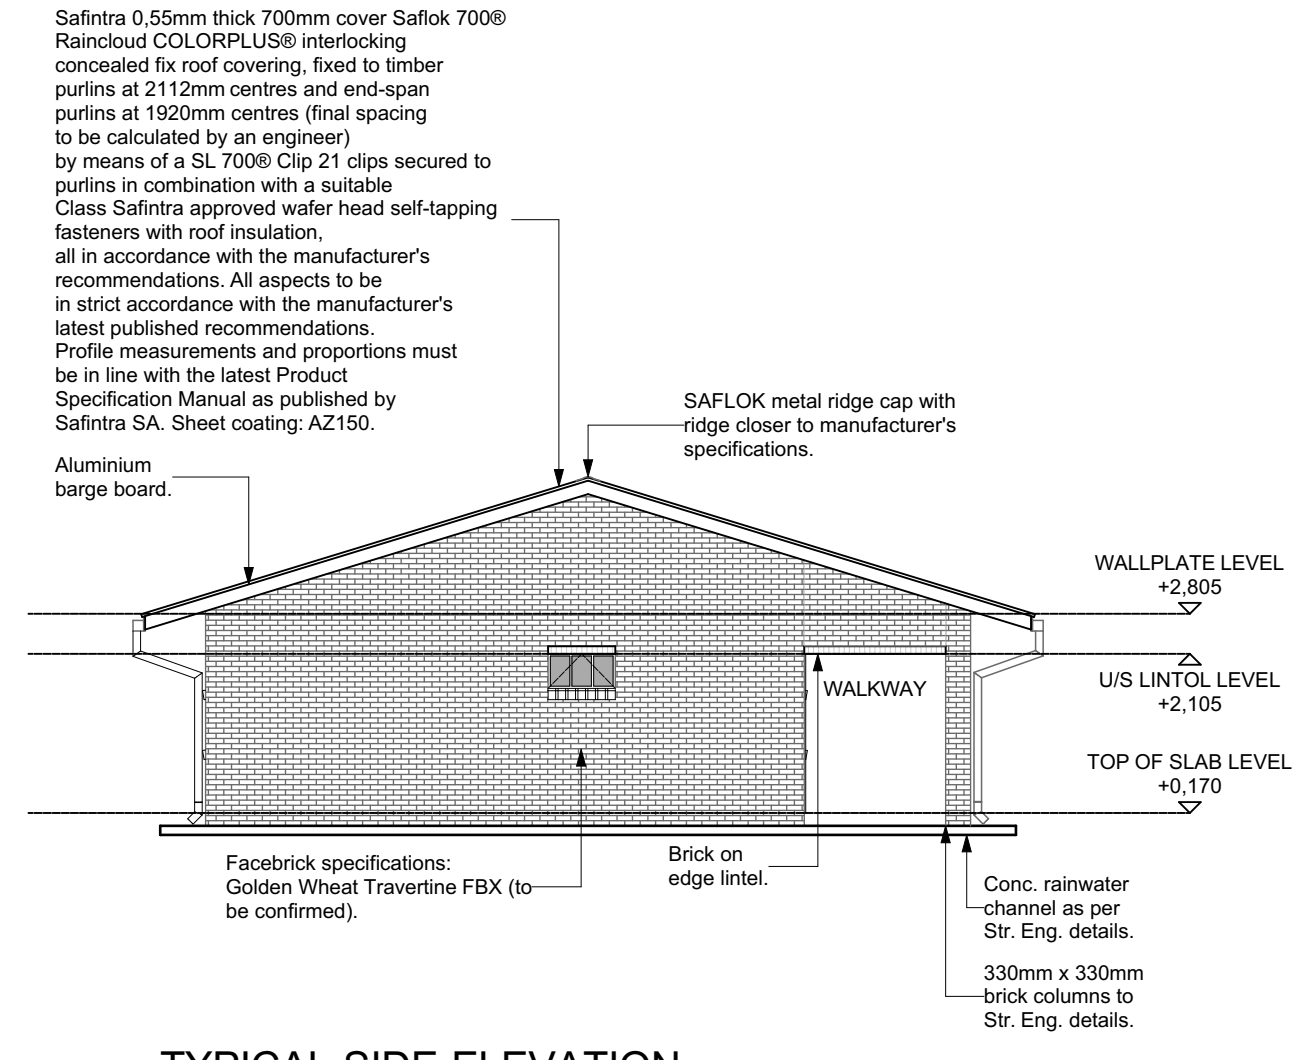

Typical Side Elevation
Scale - 1:100

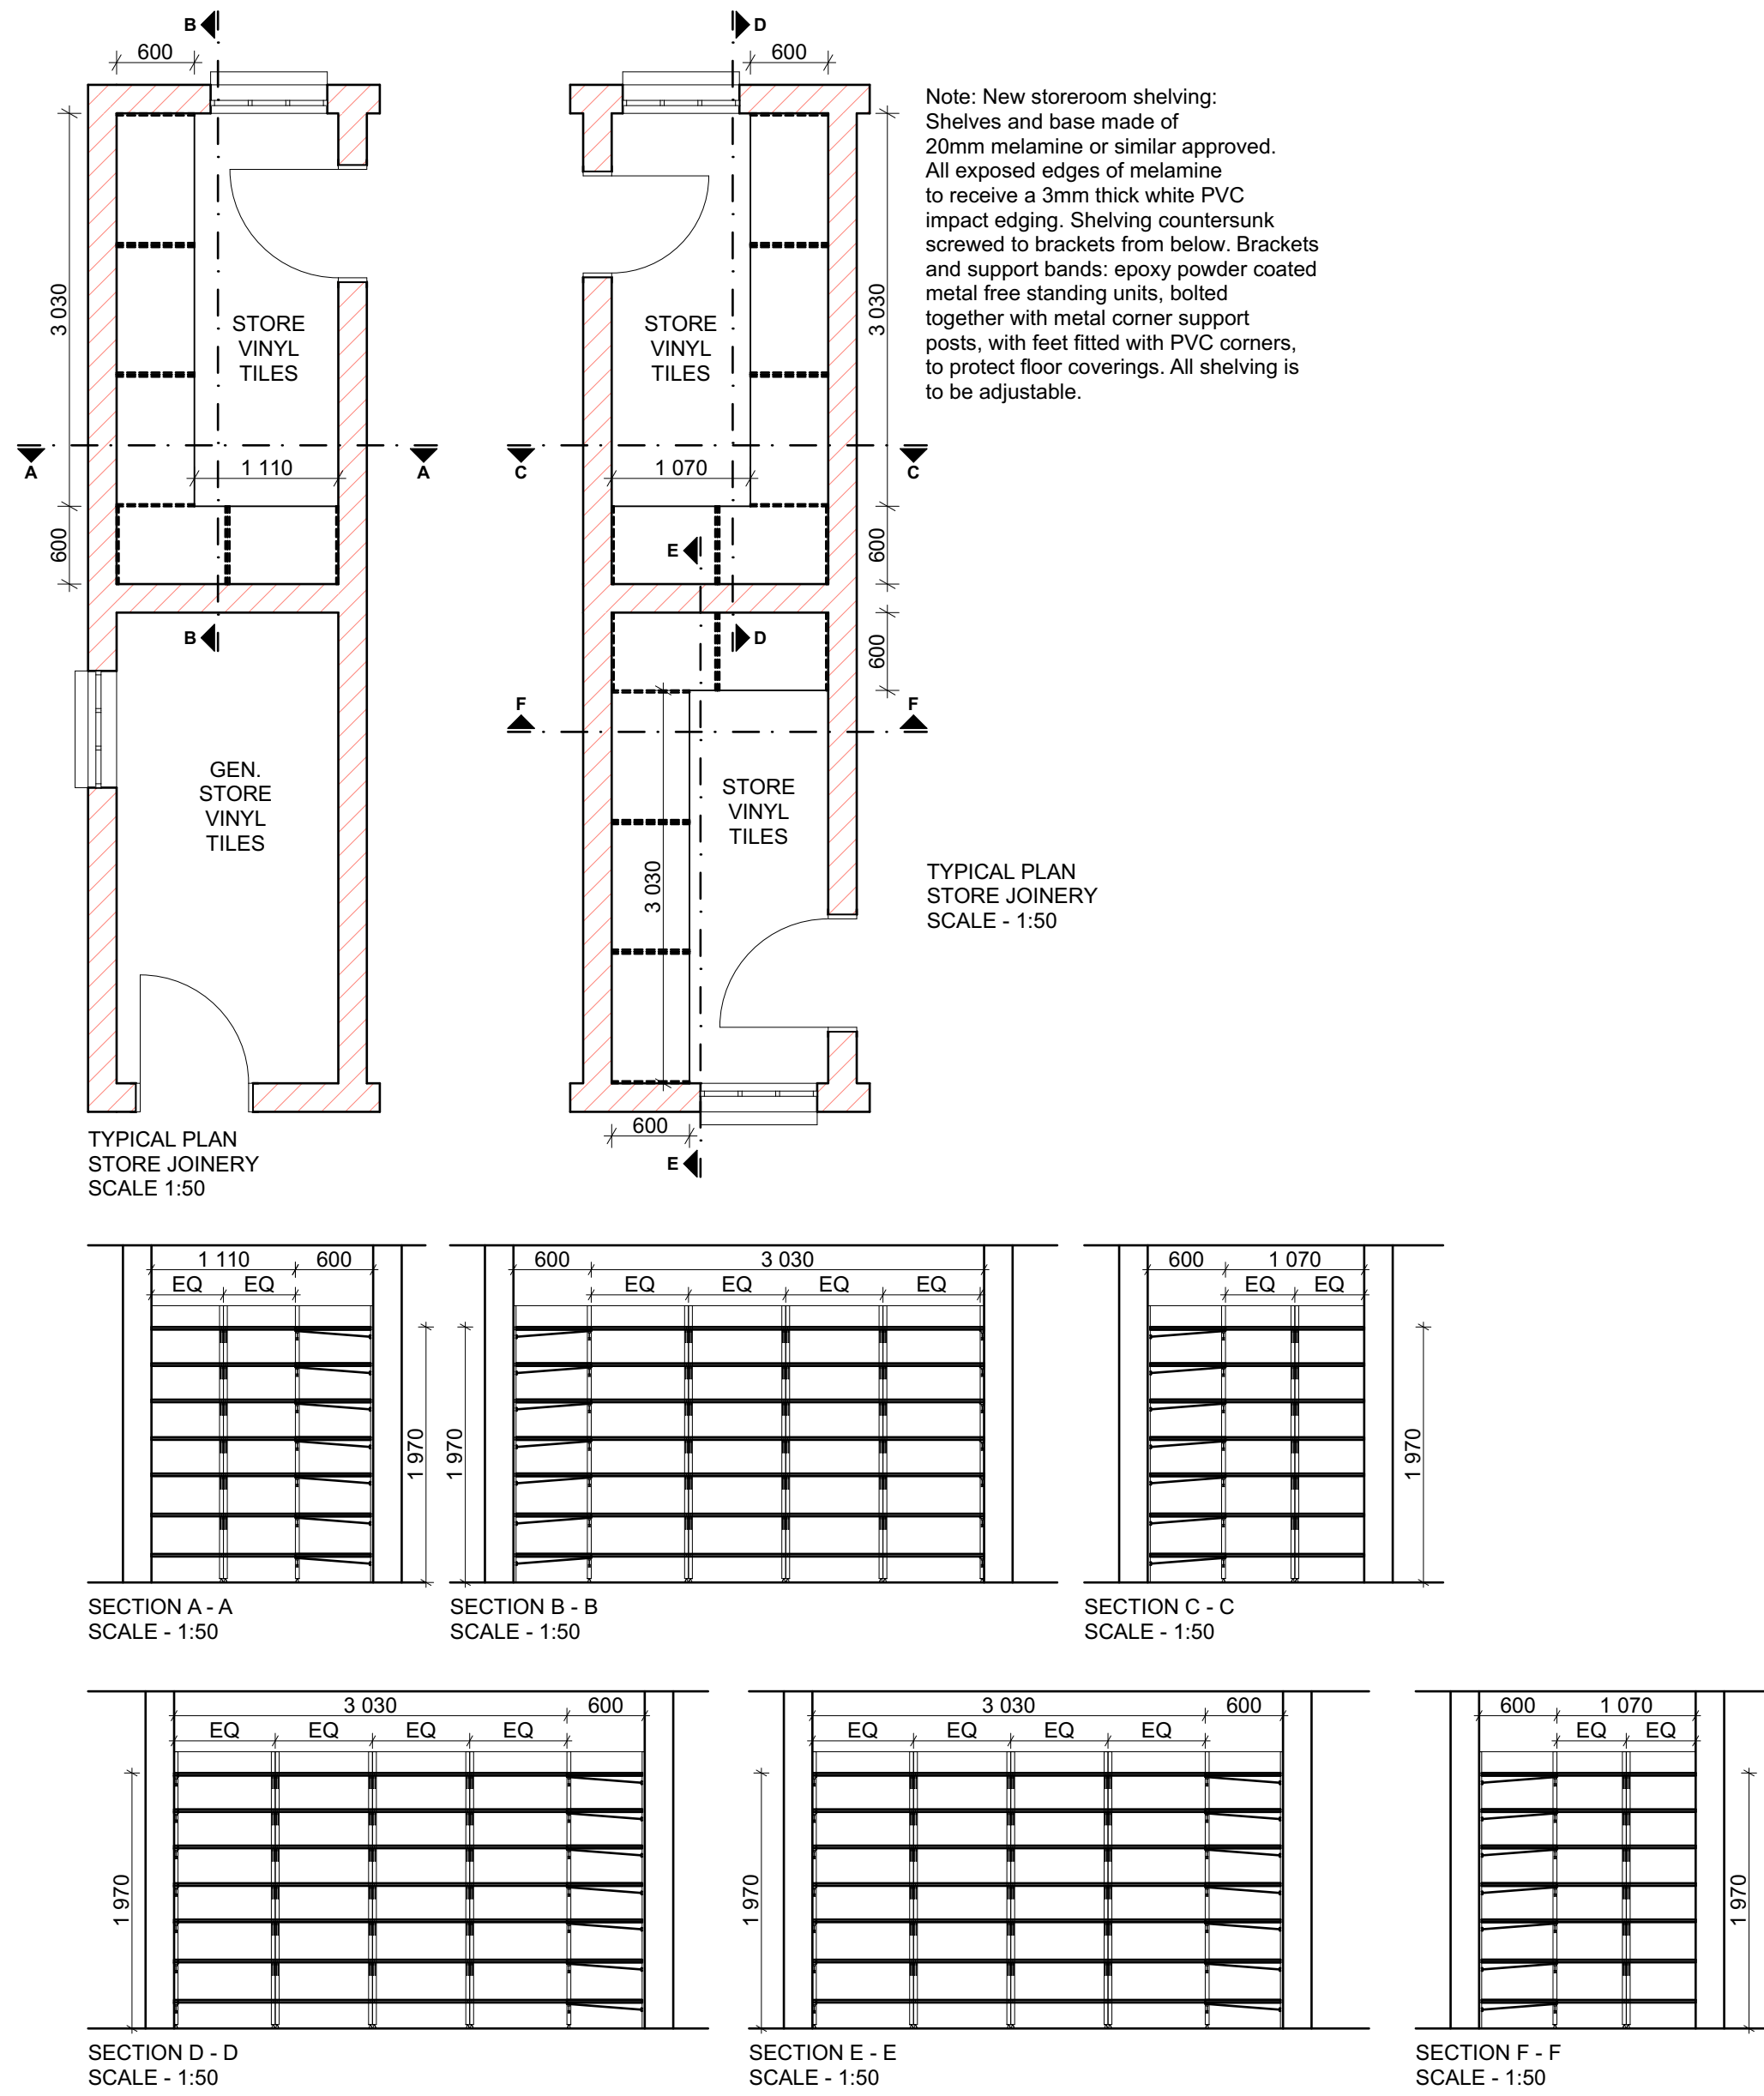

Note: New store room shelving: Shelves and base made of 20mm melamine or similar approved. All exposed edges of melamine to receive a 3mm thick white PVC impact edging. Shelving countertop screwed to brackets from below. Brackets and support bands: epoxy powder coated metal free standing units, bolted together with metal corner support posts, with feet filled with PVC corners, to protect floor coverings. All shelving is to be adjustable.

- NOTES:
1. All boundaries, dimensions and levels are to be checked on site before construction and any discrepancies are to be reported to the office of the Architect.
 2. Partial Service: Any discrepancies with site or other information is to be advised to the Architect and direction or approval is to be sought before the implementation of the detail.
 3. Do not scale this drawing.
 4. For the purpose of coordination, all relevant parties must check this information prior to implementation and report any discrepancies to the Architect.

Revisions:			
Rev No:	Date:	Description:	Rev By:
A	17/03/23	For Information Purposes Only	KG

Architect :

Name :

Signature :

Client :

Name :

Signature :



Project:	
CONDITION ASSESSMENT DR. BOHMER SECONDARY SCHOOL	
Drawing description:	
PROPOSED NEW CLASSROOMS FLOOR PLAN - 6 NEW CLASSROOMS	
Drawing:	ISENZKO ENGINEERING
Scale: AS SHOWN ON DRAWING	
FOR INFORMATION	
Drawing Number:	Revision:
062-DRB-109	A